
# CITY OF KELSO SOUTHWEST WASHINGTON REGIONAL AIRPORT

TASK ORDER #4 - FINAL DESIGN APRON/TAXILANE RECONSTRUCTION **APRIL 2024** 

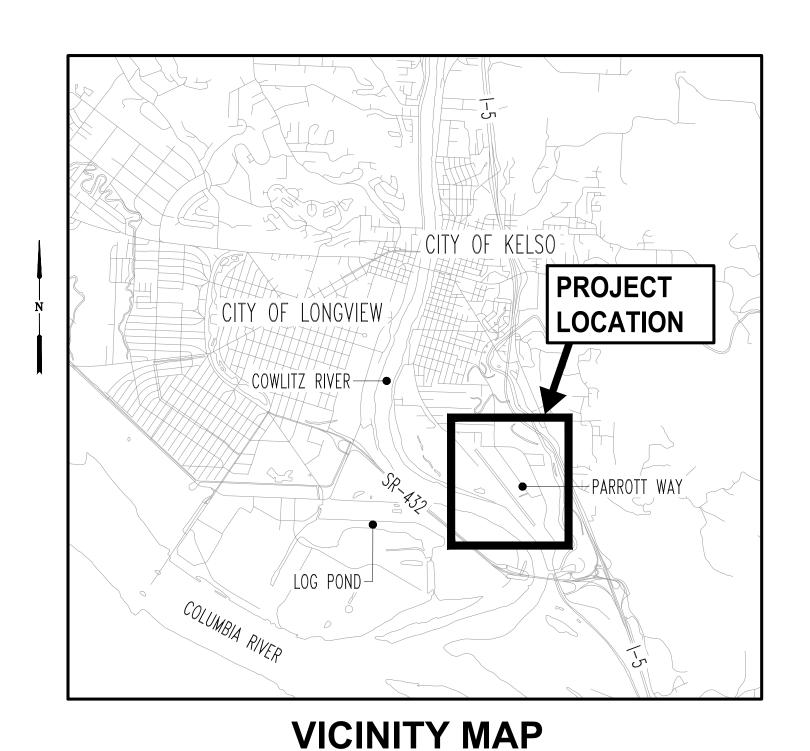

**NO SCALE** 

RUNWAY 12-30-

**APPROXIMATE** 

COWEEMAN RIVER ------

**WORK AREA** 

PARROTT WAY

SHE	SHEET INDEX				
SHEET NUMBER	DRAWING NUMBER	DRAWING TITLE			
1	G-01	COVER SHEET			
2	G-02	SITE AND SURVEY CONTROL PLAN			
3	G-03	SAFETY AND PHASING PLAN OVERVIEW			
4	G-04	SAFETY AND PHASING PLAN - WORK AREAS 1 & 2			
5	G-05	SAFETY AND PHASING NOTES			
6	C-01	EROSION CONTROL PLAN			
7	C-02	EROSION CONTROL NOTES AND DETAILS			
8	C-03	DEMOLITION PLAN			
9	C-04	PAVING LAYOUT PLAN			
10	C-05	TAXIWAY PLAN AND PROFILE			
11	C-06	PAVING PLAN AND POINT SCHEDULE			
12	C-07	PAVEMENT SECTIONS			
13	C-08	GRADING AND DRAINAGE PLAN			
14	C-09	DRAINAGE DETAILS			
15	C-10	PAVEMENT MARKING PLAN AND DETAIL			

## **LEGEND EXISTING THRESHOLD SITING SURFACE** EXISTING RUNWAY SAFETY AREA **EXISTING RUNWAY OBJECT FREE AREA EXISTING RUNWAY OBSTACLE FREE ZONE EXISTING RUNWAY PROTECTION ZONE EXISTING TAXIWAY SAFETY AREA EXISTING TAXIWAY OBJECT FREE AREA** PROPOSED CONTRACTOR HAUL ROUTE EXISTING CHAIN LINK FENCE PROPOSED SAWCUT **\*\*\*\*\*\*** EXISTING STORM DRAIN EXISTING WATER LINE EXISTING ELECTRICAL LINE **EXISTING SANITARY SEWER LINE EXISTING COMMUNICATION LINE** EXISTING OVERHEAD POWER LINE EXISTING GAS LINE EXISTING RIGHT OF WAY/PROPERTY LINE EXISTING TELEPHONE HANDHOLE **EXISTING POWER VAULT** EXISTING TRANSFORMER EXISTING POWER POLE **EXISTING WATER VAULT** EXISTING CATCH BASIN **EXISTING STORM DRAIN MANHOLE EXISTING SEWER MANHOLE EXISTING SIGN**

#### **ABBREVIATIONS CONT. ABBREVIATIONS MECHANICAL JOINT**

AASHTO AMERICAN ASSOCIATION OF STATE HIGHWAY AND TRANSPORTATION OFFICIALS ASPHALT CONCRETE PAVEMENT/ASBESTOS CONCRETE PIPE AIRCRAFT OPERATIONS AREA AMERICAN SOCIETY FOR TESTING MATERIALS **BACK OF WALK CATCH BASIN** COMMUNITY DEVELOPMENT BLOCK GRANT CENTERLINE CORRUGATED METAL PIPE CLEANOUT CONCRETE CRUSHED SURFACING BASE COURSE CRUSHED SURFACING TOP COURSE **DUCTILE IRON** EACH DEPARTMENT OF ECOLOGY ELEVATION **EDGE OF PAVEMENT EROSION AND SEDIMENT CONTROL EXISTING** FINISHED GRADE FIRE HYDRANT FLANGE/FLOW LINE FIBER OPTIC FACE OF WALK FT FOOT/FEET

GALVANIZED

INCHES

MAXIMUM

MANHOLE

MINIMUM

HOT MIX ASPHALT

INVERT ELEVATION

**INFLOW & INFILTRATION** 

HIGH DENSITY POLYETHYLENE

NATIONAL PIPE THREAD ON CENTER OFF OCCUPATIONAL SAFETY AND HEALTH ADMINISTRATION PRIMARY AIRPORT CONTROL STATION

**TAXILANE TAXIWAY TAXIWAY** PORTLAND CEMENT CONCRETE

PLAIN END **PROPOSED** POLY VINYL CHLORIDE

RESIDENT PROJECT REPRESENTATIVE

**TELECOMMUNICATIONS** 

**RUNWAY RUNWAY** 

SECONDARY AIRPORT CONTROL STATION

SCHEDULE SANITARY SEWER STORM DRAIN **STATION** 

TOP BACK OF CURB **TEMPORARY EROSION & SEDIMENT CONTROL** 

WASHINGTON INDUSTRIAL SAFETY AND HEALTH ACT

WATER SERVICE

WASHINGTON STATE DEPARTEMENT OF ECOLOGY WASHINGTON STATE DEPARTMENT OF

TRANSPORTATION

**CONTACTS** 


SOUTHWEST WASHINGTON REGIONAL AIRPORT AIRPORT MANAGER - DARR KIRK

**CENTURY WEST ENGINEERING** PROJECT MANAGER - CELESTE LOW, PE PROJECT CIVIL ENGINEER - TRACY SALGADO, EIT

EXISTING CULVERT

**EXISTING POWER HANDHOLE** 

**EXISTING WATER METER** 

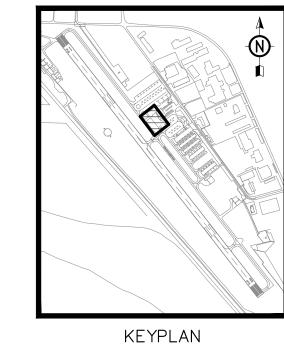



SITE MAP

**NO SCALE** 



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CENTURY	BOTHELL OFFICE	DESIGNED BY: TJS
WEST	22232 17TH AVENUE, SUITE 206 BOTHELL, WA 98021 — 425.286.6602	DRAWN BY: TJS
GINEERIN	G 420.200.0002	CHECKED BY: CRL
APRIL 2024	PROJECT NO: 35005.004.03	SCALE: AS NOTED

SOUTHWEST WASHINGTON REGIONAL AIRPORT TASK ORDER #4 - FINAL DESIGN APRON/TAXILANE RECONSTRUCTION


**COVER SHEET** 

SHEET NO.

G-01

1 OF 15

DRAWING NO.

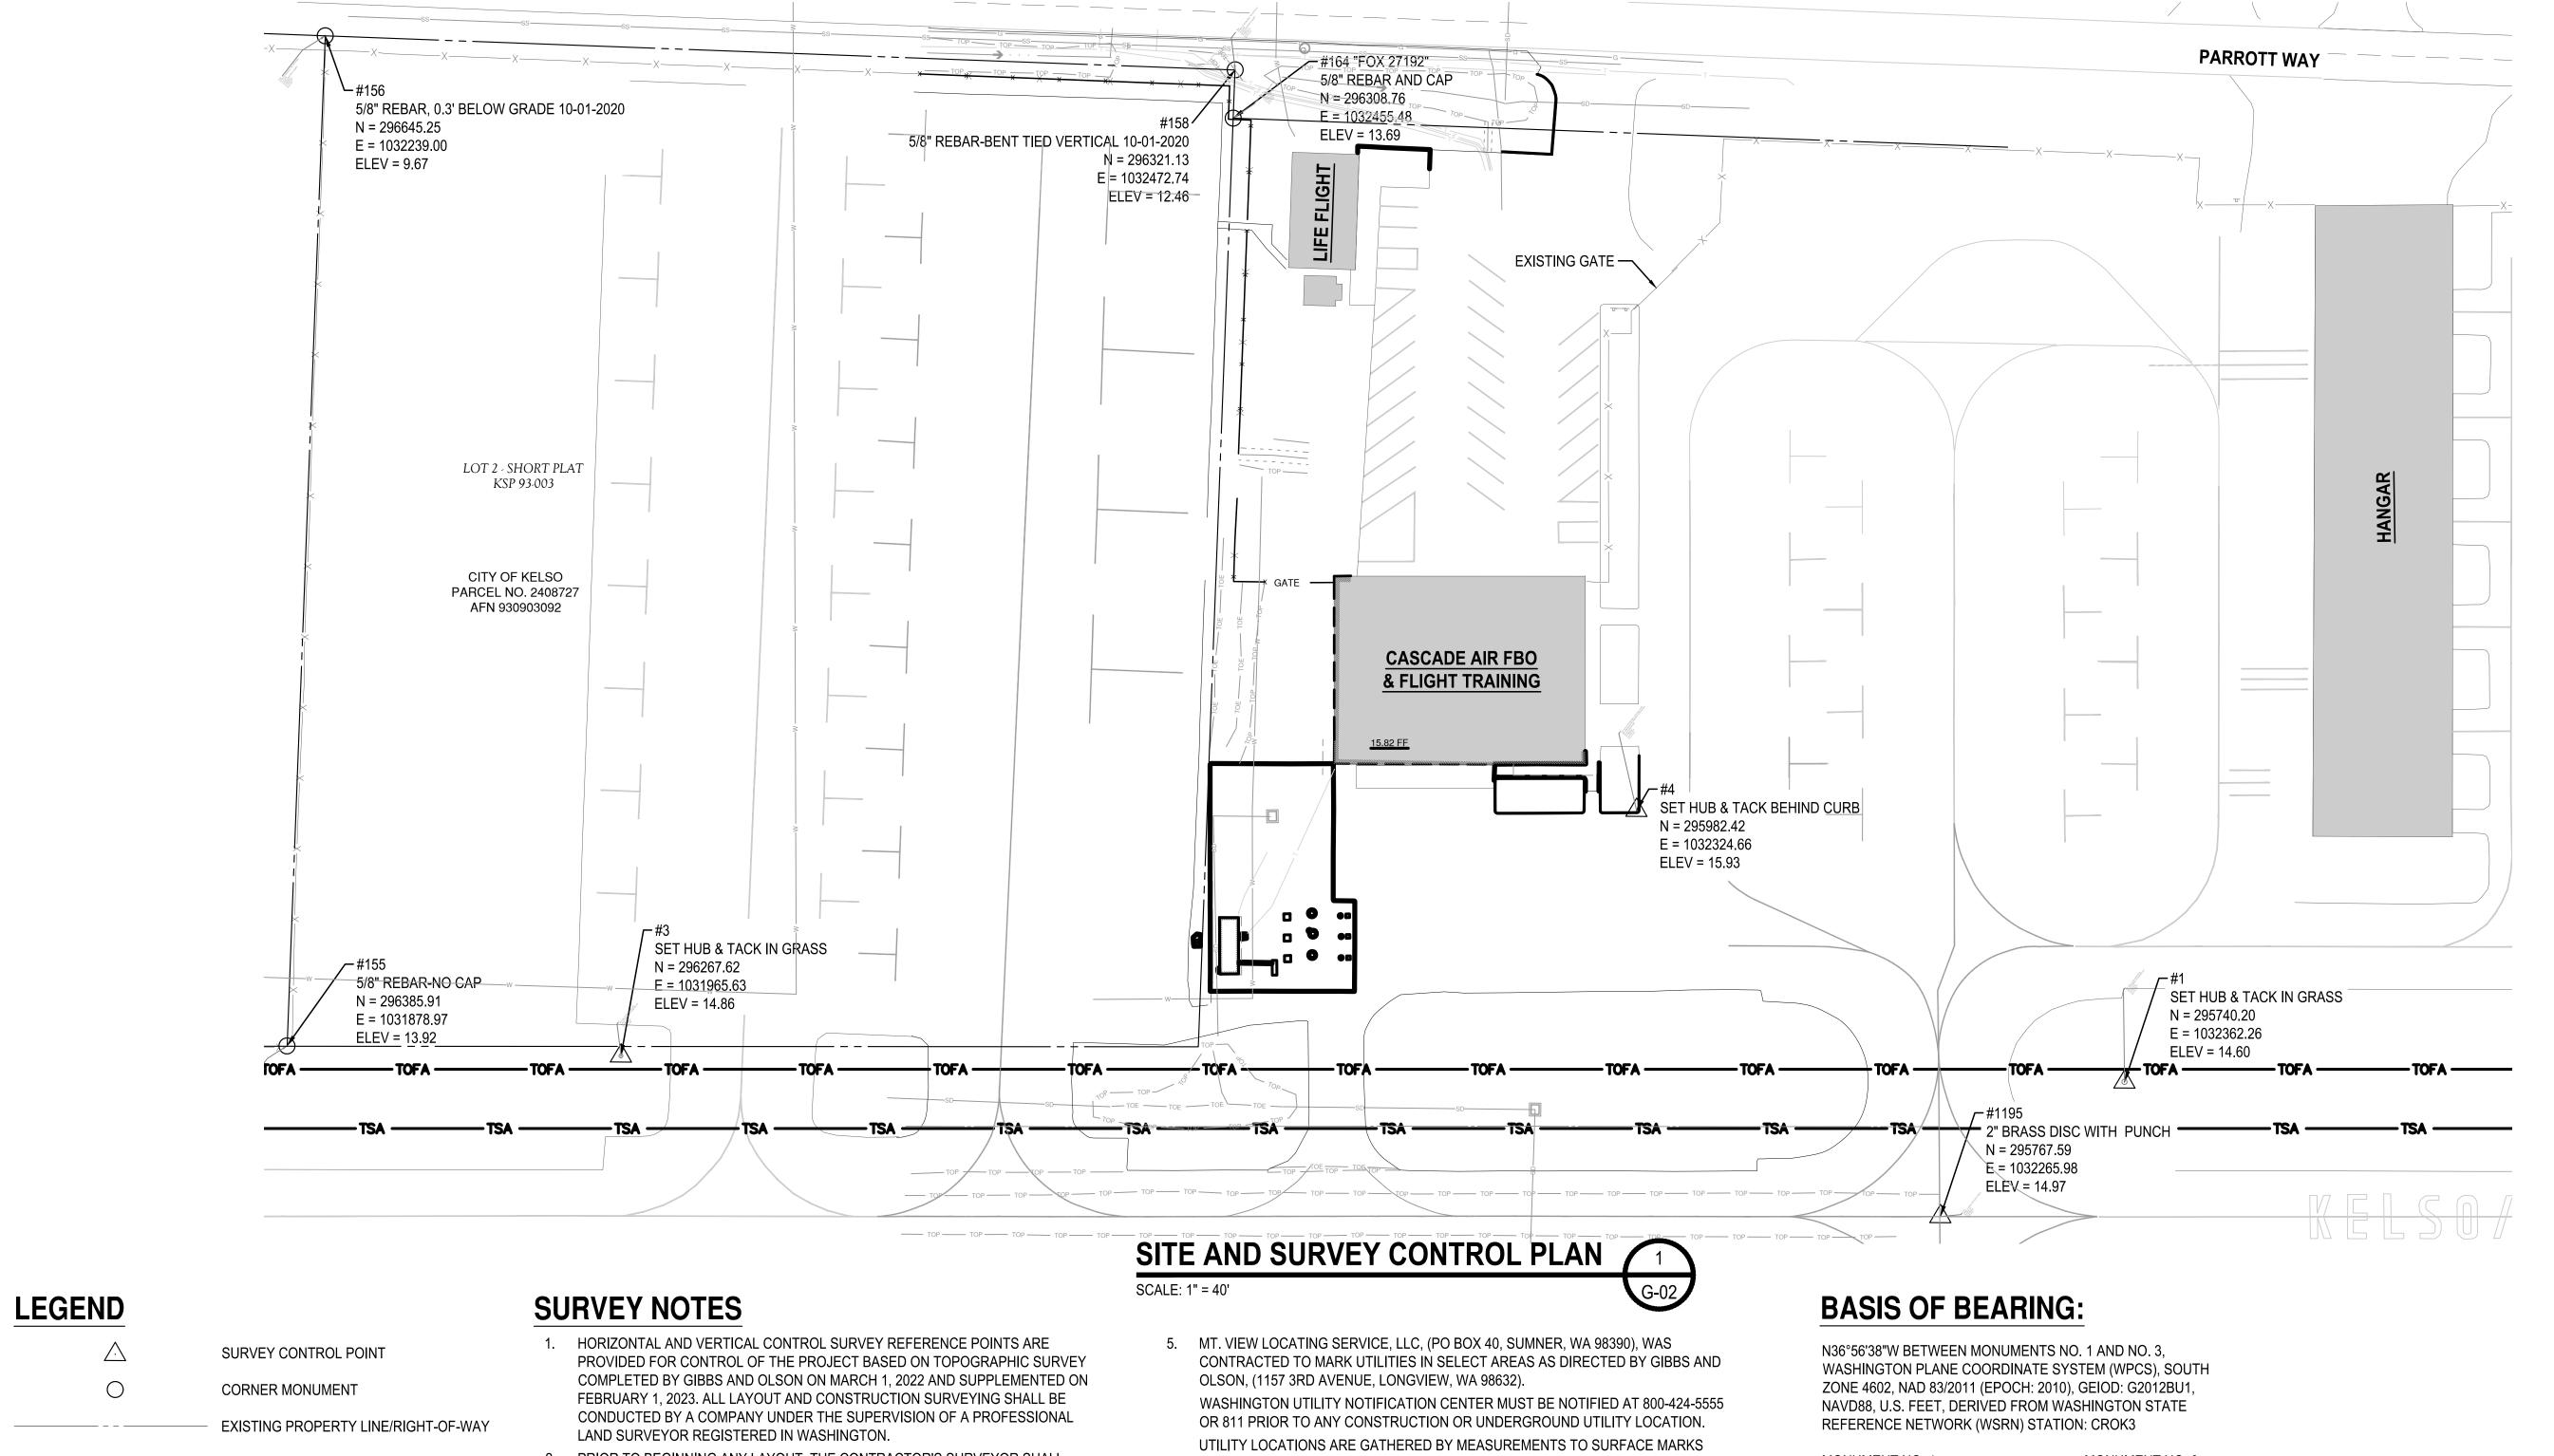

- 2. PRIOR TO BEGINNING ANY LAYOUT, THE CONTRACTOR'S SURVEYOR SHALL OCCUPY ALL REFERENCE CONTROL POINTS SHOWN ON THIS SHEET AND VERIFY DATA GIVEN. ANY DISCREPANCY SHALL IMMEDIATELY BE BROUGHT TO THE ENGINEER'S ATTENTION FOR CLARIFICATION OR CORRECTION. NOTES SHOWING CONFIRMATION OF THE HORIZONTAL AND VERTICAL IN ACCORDANCE WITH THE GENERAL CONTRACT PROVISIONS SHALL BE PROVIDED TO THE ENGINEER PRIOR TO STARTING CONSTRUCTION.
- 3. WORK PERFORMED USING A 2 SECOND TOPCON GT-502 ROBOTIC TOTAL STATION, TOPCON HIPER-VR GPS-RTK EQUIPMENT, PRECISION EXCEEDS REQUIREMENTS OF W.A.C. 332-130-090
- 4. THE PURPOSE OF THIS TOPOGRAPHIC SURVEY IS FOR CIVIL ENGINEERING AND ARCHITECTURAL DESIGN. THIS IS NOT A BOUNDARY SURVEY.


AND LOCATION PAINT PROVIDED BY MT. VIEW LOCATING SERVICES, LLC IN THE FIELD. SURVEYOR MAKES NO GUARANTEE OF THE UNDERGROUND UTILITIES SHOWN IN THE AREA. THE SURVEYOR FURTHER DOES NOT WARRANT THAT THE UNDERGROUND UTILITIES SHOWN ARE IN THE EXACT LOCATION INDICATED.

EXISTING SITE FEATURE PORTRAYED AS BACKGROUND INFORMATION ON ALL PLANS IN THIS DRAWING SET ARE BASED ON THE BEST INFORMATION AVAILABLE AND WERE COMPILED USING INFORMATION OBTAINED FROM RECORD DRAWINGS PROVIDED BY THE OWNER, GIS, AND A TOPOGRAPHIC SURVEY. CONTRACTOR SHALL VERIFY ALL EXISTING SITE CONDITIONS IN THE FIELD AND NOTIFY THE ENGINEER IMMEDIATELY IF THERE ARE DISCREPANCIES TO WHAT IS SHOWN ON THESE PLANS.

MONUMENT NO. 1 MONUMENT NO. 3 N: 295740.20 N: 296267.62 E: 1032362.26 E: 1031965.63 ELEV: 14.60 ELEV: 14.86 LAT: N046° 07' 08.3175" LAT: N046° 07' 13.4028" LON: W122° 53' 53.5079" LON: W122° 53' 59.3638"

UNLESS OTHERWISE NOTED, DISTANCES ARE GROUND DISTANCES. TO CALCULATE GRID DISTANCE, MULTIPLY GROUND DISTANCE BY THE COMBINED SCALE FACTOR: 0.99994679

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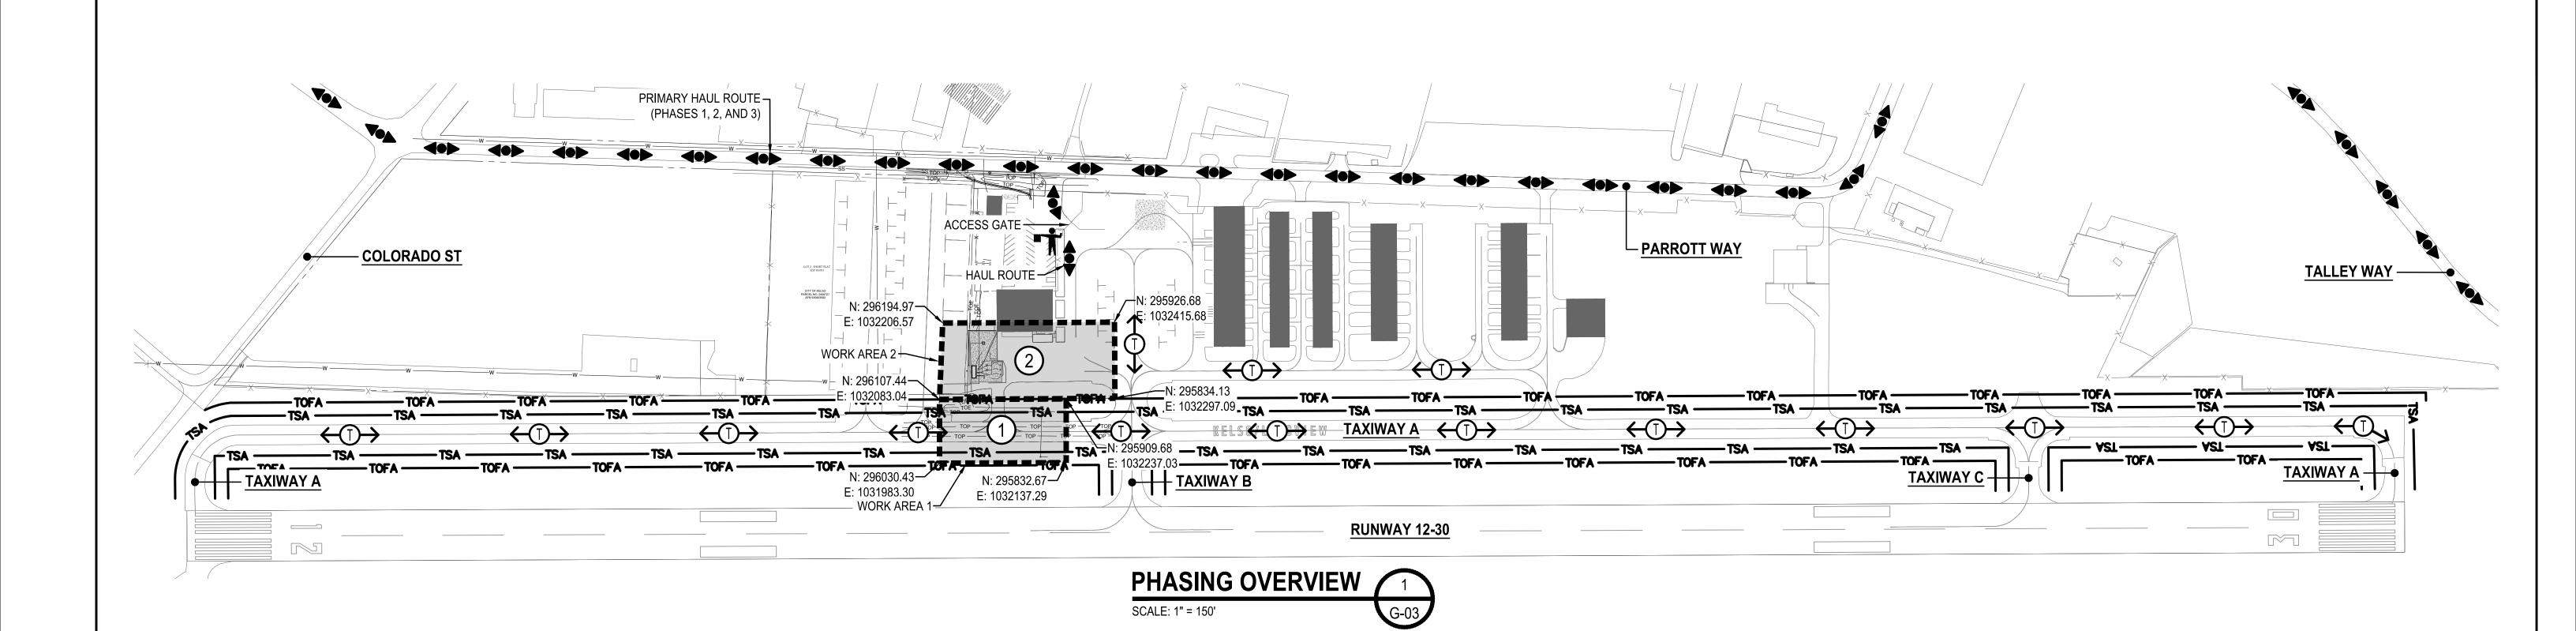
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TASK ORDER #4 - FINAL DESIGN	
APRON/TAXILANE RECONSTRUCTION	
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SITE AND SURVEY CONTROL PLAN

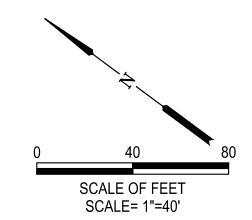
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2 OF 15








## **GENERAL NOTES**

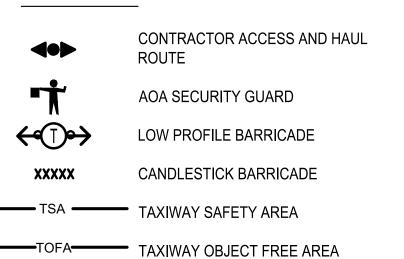- ALL WORK SHALL BE SEQUENTIAL AS NOTED IN THE "CONSTRUCTION PHASING & OPERATION CONSTRAINTS" TABLE. CONCURRENT WORK SHALL NOT BE ALLOWED.
- AREAS WHERE ACCESS/HAUL ROUTES CROSS ACTIVE AIRCRAFT AREAS
   AND IN FRONT OF EXISTING HANGARS SHALL BE CONTINUOUSLY
   MONITORED FOR FOD. THE CONTRACTOR SHALL NOT, UNDER ANY
   CIRCUMSTANCE, BLOCK ACCESS TO THESE HANGARS.
- 3. CONTRACTOR'S ACCESS ROAD, HAUL ROADS, AND STAGING AREAS SHALL BE CONSTRUCTED AS NEEDED, AT CONSTRACTOR'S EXPENSE. ALL DISTURBED AREAS SHALL BE RESTORED TO ORIGINAL OR BETTER CONDITION AT NO ADDITIONAL COST TO THE OWNER.
- 4. ALL PAVEMENT SURFACES SHALL BE PROTECTED FROM DAMAGE DUE 7. TO CONSTRUCTION ACTIVITY. RESTORE DAMAGED PAVEMENT TO ORIGINAL OR BETTER CONDITION AT NO COST TO THE OWNER.
- 5. CONTRACTOR SHALL CONTROL DUST AND SMOKE RELATED TO CONSTRUCTION ACTIVITIES AT ALL TIMES.
- 6. ACTIVE AIRCRAFT SURFACES SHALL BE KEPT CLEAN AS WORK PROGRESSES AND SHALL BE FREE OF FOD (FOREIGN OBJECT DEBRIS), BEFORE THESE SURFACES ARE OPENED TO AIRCRAFT OPERATIONS.
- WHENEVER DIRECTED BY THE ENGINEER, THE CONTRACTOR SHALL BEGIN CLEANUP OPERATIONS OR SHUT DOWN CLEANUP OPERATIONS ALREADY IN PROGRESS. IN THE EVENT THE AIRPORT OR ENGINEER DETERMINES ANY ACTIVE AIRCRAFT MOVEMENT AREA TO BE UNUSABLE OR HAZARDOUS DUE TO CONSTRUCTION GENERATED DEBRIS, AND THE CONTRACTOR IS NOT ON SITE OR NOT ABLE TO RESPOND PROMPTLY, CLEANUP EQUIPMENT WILL BE CALLED TO THE AIRPORT. THE RESULTING COST WILL BE RECOVERED AS A LIQUIDATED DAMAGE AGAINST THE CONTRACTOR.



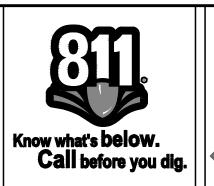



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APRIL 2024	PROJECT NO: 35005.004.03	SCALE: AS NOTED

SOUTHWEST WASHINGTON REGIONAL AIRPORT
TASK ORDER #4 - FINAL DESIGN
APRON/TAXILANE RECONSTRUCTION


SAFETY AND PHASING PLAN OVERVIEW

SHEET NO.


3 OF 15

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G-03

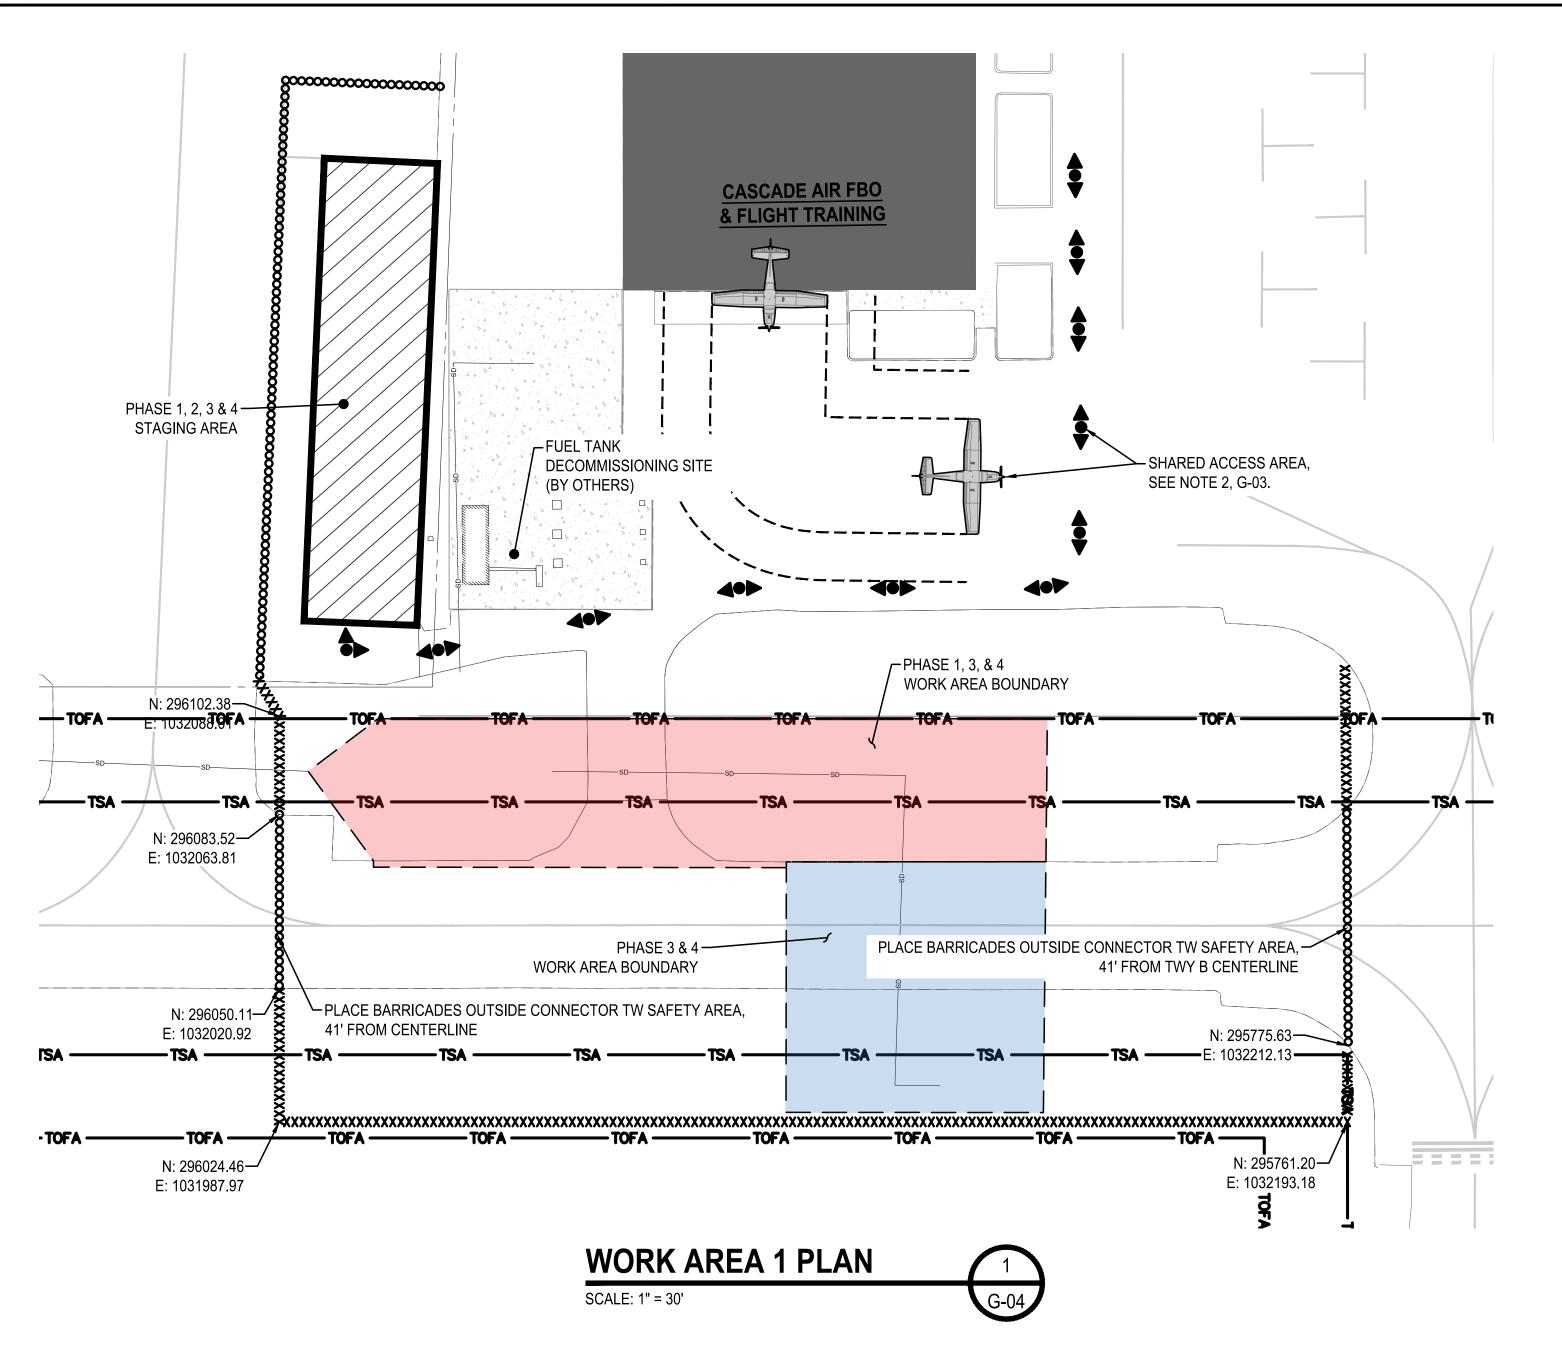

		CONST	RUCTI	ON PHASING 8	OPERATION	ON CONSTI	RAINTS		
PROJECT	DURATION	WORK	SEQUENCE	WORK SCORE	RUNWAY STATUS		TAXIWAY STATUS		FBO HANGAR
PHASE	DURATION	AREA	SEQUENCE	WORK SCOPE	RW 12-30	TW A	TW B	TW C	ACCESS
1	14	1	1	- ASPHALT REMOVAL - GRADING - STORM/SUBDRAIN - BASE ROCK	OPEN	PARTIAL CLOSURE	OPEN	OPEN	OPEN
2	18	2	2	- ASPHALT REMOVAL - GRADING - STORM/SUBDRAIN - BASE ROCK	OPEN	OPEN	OPEN	OPEN	CLOSED
3	5	2	3	- ASPHALT REMOVAL - GRADING - STORM - BASE ROCK	OPEN	PARTIAL CLOSURE	OPEN	OPEN	CLOSED
4A	3	1 & 2	4	- PAVING - MARKING - HYDROSEEDING	OPEN	PARTIAL CLOSURE	OPEN	OPEN	CLOSED
4B	1	1 & 2	5	- FINAL MARKING	OPEN	PARTIAL CLOSURE	OPEN	OPEN	CLOSED

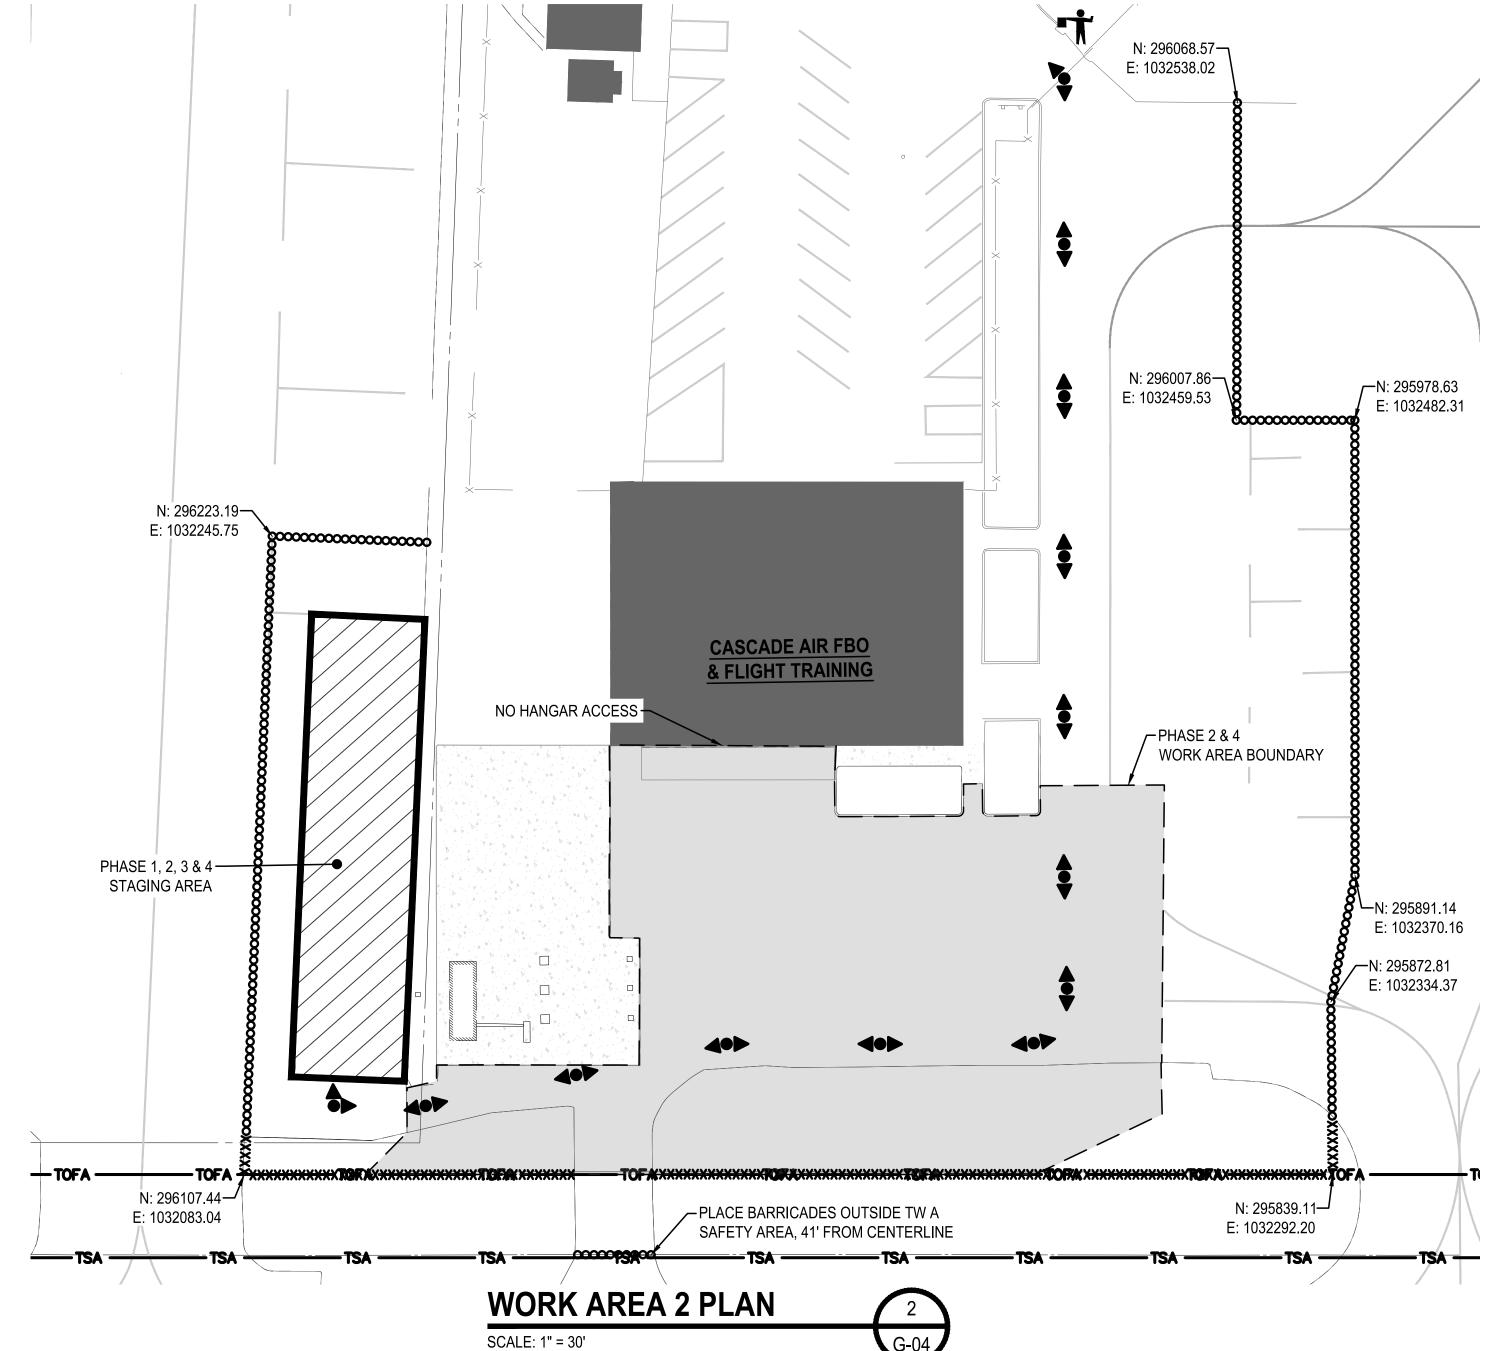

#### LEGEND CONT. **LEGEND**

PROPOSED CONTRACTOR STAGING AREA BY PHASE CONTRACTOR ACCESS AND HAUL

AOA SECURITY GUARD

TAXIWAY OBJECT FREE AREA

TJS

CRL

AS NOTED

CANDLESTICK BARRICADE TSA — TAXIWAY SAFETY AREA

LOW PROFILE BARRICADE

WORK AREA BOUNDARY





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APRIL 2024	35005.004.03	AS NO

SOUTHWEST WASHINGTON REGIONAL AIRPO	ORT
TASK ORDER #4 - FINAL DESIGN	
APRON/TAXILANE RECONSTRUCTION	

SHEET NO. SAFETY AND PHASING PLAN - WORK AREAS 1 & 2 4 OF 15

DRAWING NO.

G-04

#### **GENERAL WORK AREA NOTES:**

- 1. THE CONTRACTOR SHALL BE RESTRICTED TO USE THE ENTRANCE AND HAULING ROUTES SHOWN ON THE DRAWINGS. FOLLOW AIRPORT AND FAA SAFETY PROCEDURES WHEN MOVING EQUIPMENT OR PERSONNEL. NO PERSONAL VEHICLES SHALL BE ALLOWED OUTSIDE OF THE STAGING AREA. THE AIRPORT MAY IMMEDIATELY REMOVE ANY PERSONNEL AND EQUIPMENT FROM THE SITE IN VIOLATION OF AIRPORT SAFETY AND SECURITY PROCEDURES.
- 2. COVER GUIDANCE SIGNS AS DIRECTED BY THE AIRPORT TO PREVENT AIRCRAFT FROM TAXIING TOWARDS CLOSED WORK AREAS.
- 3. LIMIT EQUIPMENT HEIGHT TO 30 FEET UNLESS OTHERWISE APPROVED BY THE ENGINEER.
- 4. LIMIT STOCK PILES TO 10 FEET IN HEIGHT AND AT LEAST 250 FEET FROM RUNWAY CENTERLINE AND 66 FEET FROM TAXIWAY CENTERLINE.
- 5. IN THE EVENT OF AN EMERGENCY, MOVE ALL EQUIPMENT AND PERSONNEL TO THE CONTRACTOR'S STAGING AREA UNLESS OTHERWISE DIRECTED BY THE ENGINEER.
- ACCESS TO ANY WORK AREA MUST BE AUTHORIZED BY THE ENGINEER PRIOR TO WORK IN THAT AREA. NOTIFY THE ENGINEER A MINIMUM OF 72 HOURS PRIOR TO BEGINNING WORK IN ANY AREA. NOTAMS SHALL BE ISSUED BY THE AIRPORT.
- 7. PLACE LOW LEVEL BARRICADES AS SHOWN AND DESCRIBED IN SECTION 01300 OF THE SPECIFICATIONS.
- BARRICADES SHALL BE PLACED PRIOR TO BEGINNING CONSTRUCTION OPERATIONS AND SHALL BE REMOVED WHEN TAXILANES ARE REOPENED.
- 9. RETURN ALL EQUIPMENT TO STAGING AREA AT THE END OF EACH WORK DAY.
- 10. FOR ADDITIONAL REQUIREMENTS, REFER TO SECTION 01330, AIRPORT SAFETY, IN THE TECHNICAL SPECIFICATIONS.
- THE CONTRACTOR SHALL BE RESPONSIBLE TO LOCATE AND PROTECT ALL UTILITIES DURING THIS PROJECT. THE CONTRACTOR SHALL BE RESPONSIBLE FOR CALLING THE UTILITY NOTIFICATION CENTER TO LOCATE PUBLIC UTILITIES AND FOR ANY ADDITIONAL UTILITY LOCATES INCLUDING HIRING A PRIVATE LOCATE SERVICE IF REQUIRED. ANY UTILITIES DAMAGED IN CONJUNCTION WITH THE CONSTRUCTION ACTIVITIES SHALL BE REPLACED AND/OR REPAIRED BY THE CONTRACTOR AS APPROVED BY THE OWNER.
- 12. ALL HAUL ROUTES SHALL BE MAINTAINED DURING CONSTRUCTION AND SHALL BE RESTORED TO ORIGINAL CONDITION BY THE CONTRACTOR UPON COMPLETION OF THE PROJECT. VERIFY CONDITION WITH OWNER PRIOR TO CONSTRUCTION.

### **CONTRACTOR'S SUPERINTENDENT AND SAFETY OFFICE:**


- THE CONTRACTOR SHALL HAVE A FULL TIME SUPERINTENDENT ON THE PROJECT SITE ANY TIME WORK IS BEING ACCOMPLISHED ON THE AIRPORT. THIS INCLUDES WORK BEING PERFORMED BY SUBCONTRACTORS OR SERVICE PROVIDERS UNLESS OTHERWISE APPROVED BY THE OWNER.
- 2. THE CONTRACTOR SHALL ASSIGN ONE PERSON TO BE THE SAFETY OFFICER DURING THE PROJECT. THE SAFETY OFFICER SHALL BE ONSITE AT ALL TIMES WHEN WORK IS OCCURRING IN THE AOA WHEN THE AIRPORT IS OPEN UNLESS OTHERWISE APPROVED BY THE OWNER. THE SAFETY OFFICER SHALL BE RESPONSIBLE FOR THE EDUCATION AND TRAINING OF ALL PERSONNEL WHO WILL ACCESS AIRPORT PROPERTY. THE OFFICER SHALL MAINTAIN RECORDS INDICATING THAT PERSONNEL HAVE BEEN TRAINED AND ARE FAMILIAR WITH SAFETY RULES AND REGULATIONS RELATED TO OPERATIONS AT THE AIRPORT DURING CONSTRUCTION. PERSONNEL WHO VIOLATE SAFETY REQUIREMENTS MAY BE REMOVED FROM THE PROJECT AT THE DISCRETION OF THE OWNER. THE SAFETY OFFICER SHALL ALSO BE RESPONSIBLE FOR FOREIGN OBJECT DEBRIS (FOD) MANAGEMENT.
- 3. THE CONTRACTOR'S SUPERINTENDENT AND SAFETY OFFICER SHALL ATTEND THE WEEKLY CONSTRUCTION

# WORK IN SAFETY AREAS AND OBJECT FREE AREAS:

- 1. NO WORK IS ALLOWED IN ACTIVE RUNWAY AND TAXIWAY SAFETY AREAS. RUNWAY SAFETY AREA (RSA) AND TAXIWAY SAFETY AREA (TSA) ARE DEFINED AS AREAS THAT SHALL BE CLEARED AND GRADED AND HAVE NO RUTS, HUMPS, OPEN TRENCHES, DEPRESSIONS, OR OTHER SURFACE VARIATIONS. THE MAXIMUM SLOPE ANYWHERE WITHIN A RUNWAY OR TAXIWAY SAFETY AREA SHALL BE 3%. IN TRANSITIONS FROM PAVED TO UNPAVED AREAS, A 1.5 INCH VERTICAL DROP IS ALLOWED. THE RUNWAY AND TAXIWAY SAFETY AREAS SHALL BE MAINTAINED AT ALL TIMES WHEN THE RUNWAY OR TAXIWAY IS OPEN TO AIR TRAFFIC. PERSONNEL, EQUIPMENT, OR MATERIAL WITHIN A RUNWAY SAFETY AREA AT ANY TIME REQUIRES A CLOSURE. SAFETY AREAS THAT ARE CLOSED FOR CONSTRUCTION MUST MEET THESE CRITERIA PRIOR TO REOPENING.
- 2. THE CONTRACTOR SHALL ANTICIPATE THE CONSTRUCTION OF TEMPORARY FILLS, COMPACTION, TRENCH BACKFILLING, AND GRADING TO MEET THE REQUIREMENTS OF "WORK IN SAFETY AREAS AND OBJECT FREE AREAS", PRIOR TO REOPENING RUNWAYS AND TAXIWAYS. THIS WORK IS CONSIDERED INCIDENTAL TO VARIOUS WORK ITEMS AND SEPARATE PAYMENT WILL NOT BE MADE.
- 3. CONTRACTOR SHALL NOT ENTER ANY ACTIVE RSA OR TSA WITHOUT AUTHORIZATION FROM THE AIRPORT. ALL EQUIPMENT, TOOLS, AND MATERIALS SHALL BE MOVED TO STAGING AREAS PRIOR TO REOPENING A RUNWAY OR TAXIWAY.
- 4. SAFETY AREA LIMITS
  - AXIWAY 39.5' FROM FROM CENTERLINE
  - RUNWAY 12-30 75' FROM CENTERLINE; 300' FROM THRESHOLD
- 5. RUNWAY AND TAXIWAY OBJECT FREE AREAS (OFA) ARE DEFINED AS AREAS THAT SHALL BE CLEAR OF FIXED OR MOVABLE OBJECTS. EQUIPMENT NOT IN USE AND MATERIAL STOCKPILES AND STORAGE SHALL BE PLACED AT LEAST 250 FEET FROM ANY RUNWAY CENTERLINE. NO WORK MAY OCCUR IN TAXIWAY OBJECT FREE AREAS UNLESS THE TAXIWAY IS CLOSED TO AIRCRAFT TRAFFIC. NO STORAGE OF EQUIPMENT, MATERIALS OR STOCKPILES IS ALLOWED WITHIN TAXIWAY OBJECT FREE AREAS.
- 6. OBJECT FREE AREA LIMITS
  - RUNWAY 12-30 250' FROM CENTERLINE
- TAXIWAYS 65.5' FROM CENTERLINE
- . RUNWAY AND TAXIWAY SAFETY AREA AND RUNWAY AND TAXIWAY OBJECT FREE AREA CRITERIA MUST BOTH BE MET PRIOR TO OPENING AN IMPACTED RUNWAY OR TAXIWAY.

#### **SEQUENCING AND WORK SCHEDULE NOTES:**


- 1. COORDINATE WORK AREA CLOSURES WITH THE AIRPORT TO ENSURE ACCESS AS NEEDED TO MAINTAIN AIRPORT OPERATIONS, INCLUDING PROVIDING FOR AND MAINTAINING ACCESS TO THE FOLLOWING:
  - ACCESS TO THE APRON AREAS
- 2. REFER TO SHEET G-04 FOR PHASE DURATIONS, WORK SCOPE AND SEQUENCING.
- 3. UNLESS NOTED OTHERWISE, WORK MAY BE 24/7 AT THE CONTRACTOR'S OPTION.

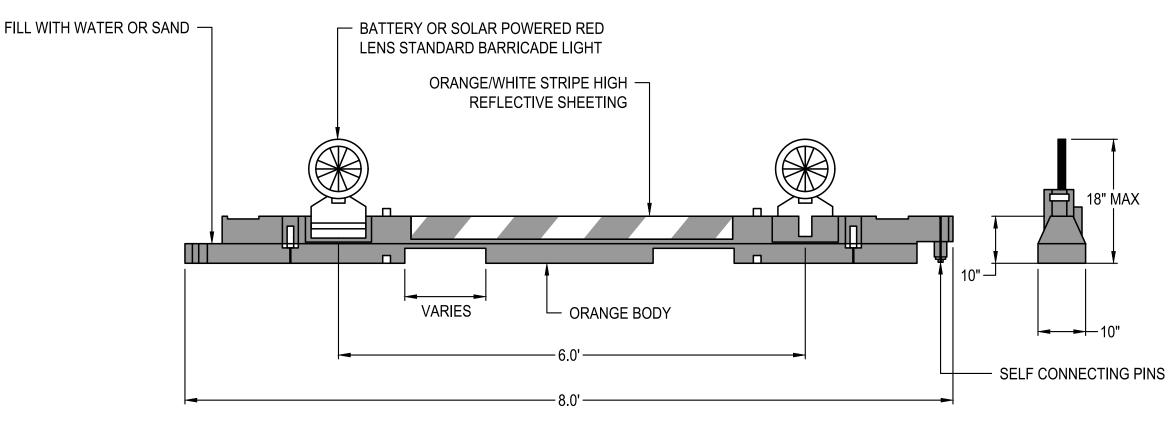

#### NOTES:

- 1. BARRICADES SHALL MEET THE REQUIREMENTS OF AC 150/5370-2, CURRENT EDITION.
- 2. PLACE BARRICADE PER THE PLANS OR AS DIRECTED BY THE RPR.
- 3. BARRICADES SHALL BE PROVIDED BY THE CONTRACTOR. THE CONTRACTOR SHALL BE RESPONSIBLE FOR PLACING, FILLING, EMPTYING, MOVING, MAINTAINING AND PROTECTING BARRICADES THROUGHOUT THE DURATION OF THE PROJECT.
- 4. LIGHTS ARE TO BE NO FARTHER APART THAN 10' WHEN PLACED.
- 5. BARRICADES SHALL BE COVERED WITH REFLECTIVE SHEETING OR OTHER MATERIAL APPROVED BY THE RPR.
- 6. BARRICADES SHALL BE APPROPRIATELY WEIGHTED DOWN TO RESTRICT MOVEMENT FROM HIGH WINDS OR PROP WASH.



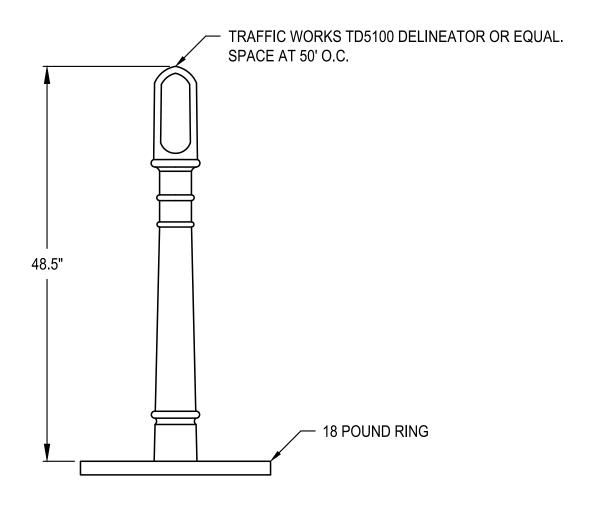

BARRICADE DELINEATOR DETAIL
(CANDLESTICK)

SCALE=NTS







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SOUTHWEST WASHINGTON REGIONAL AIRPORT TASK ORDER #4 - FINAL DESIGN APRON/TAXILANE RECONSTRUCTION


SAFETY AND PHASING NOTES

SHEET NO.

DRAWING NO.

G-05

5 OF 15

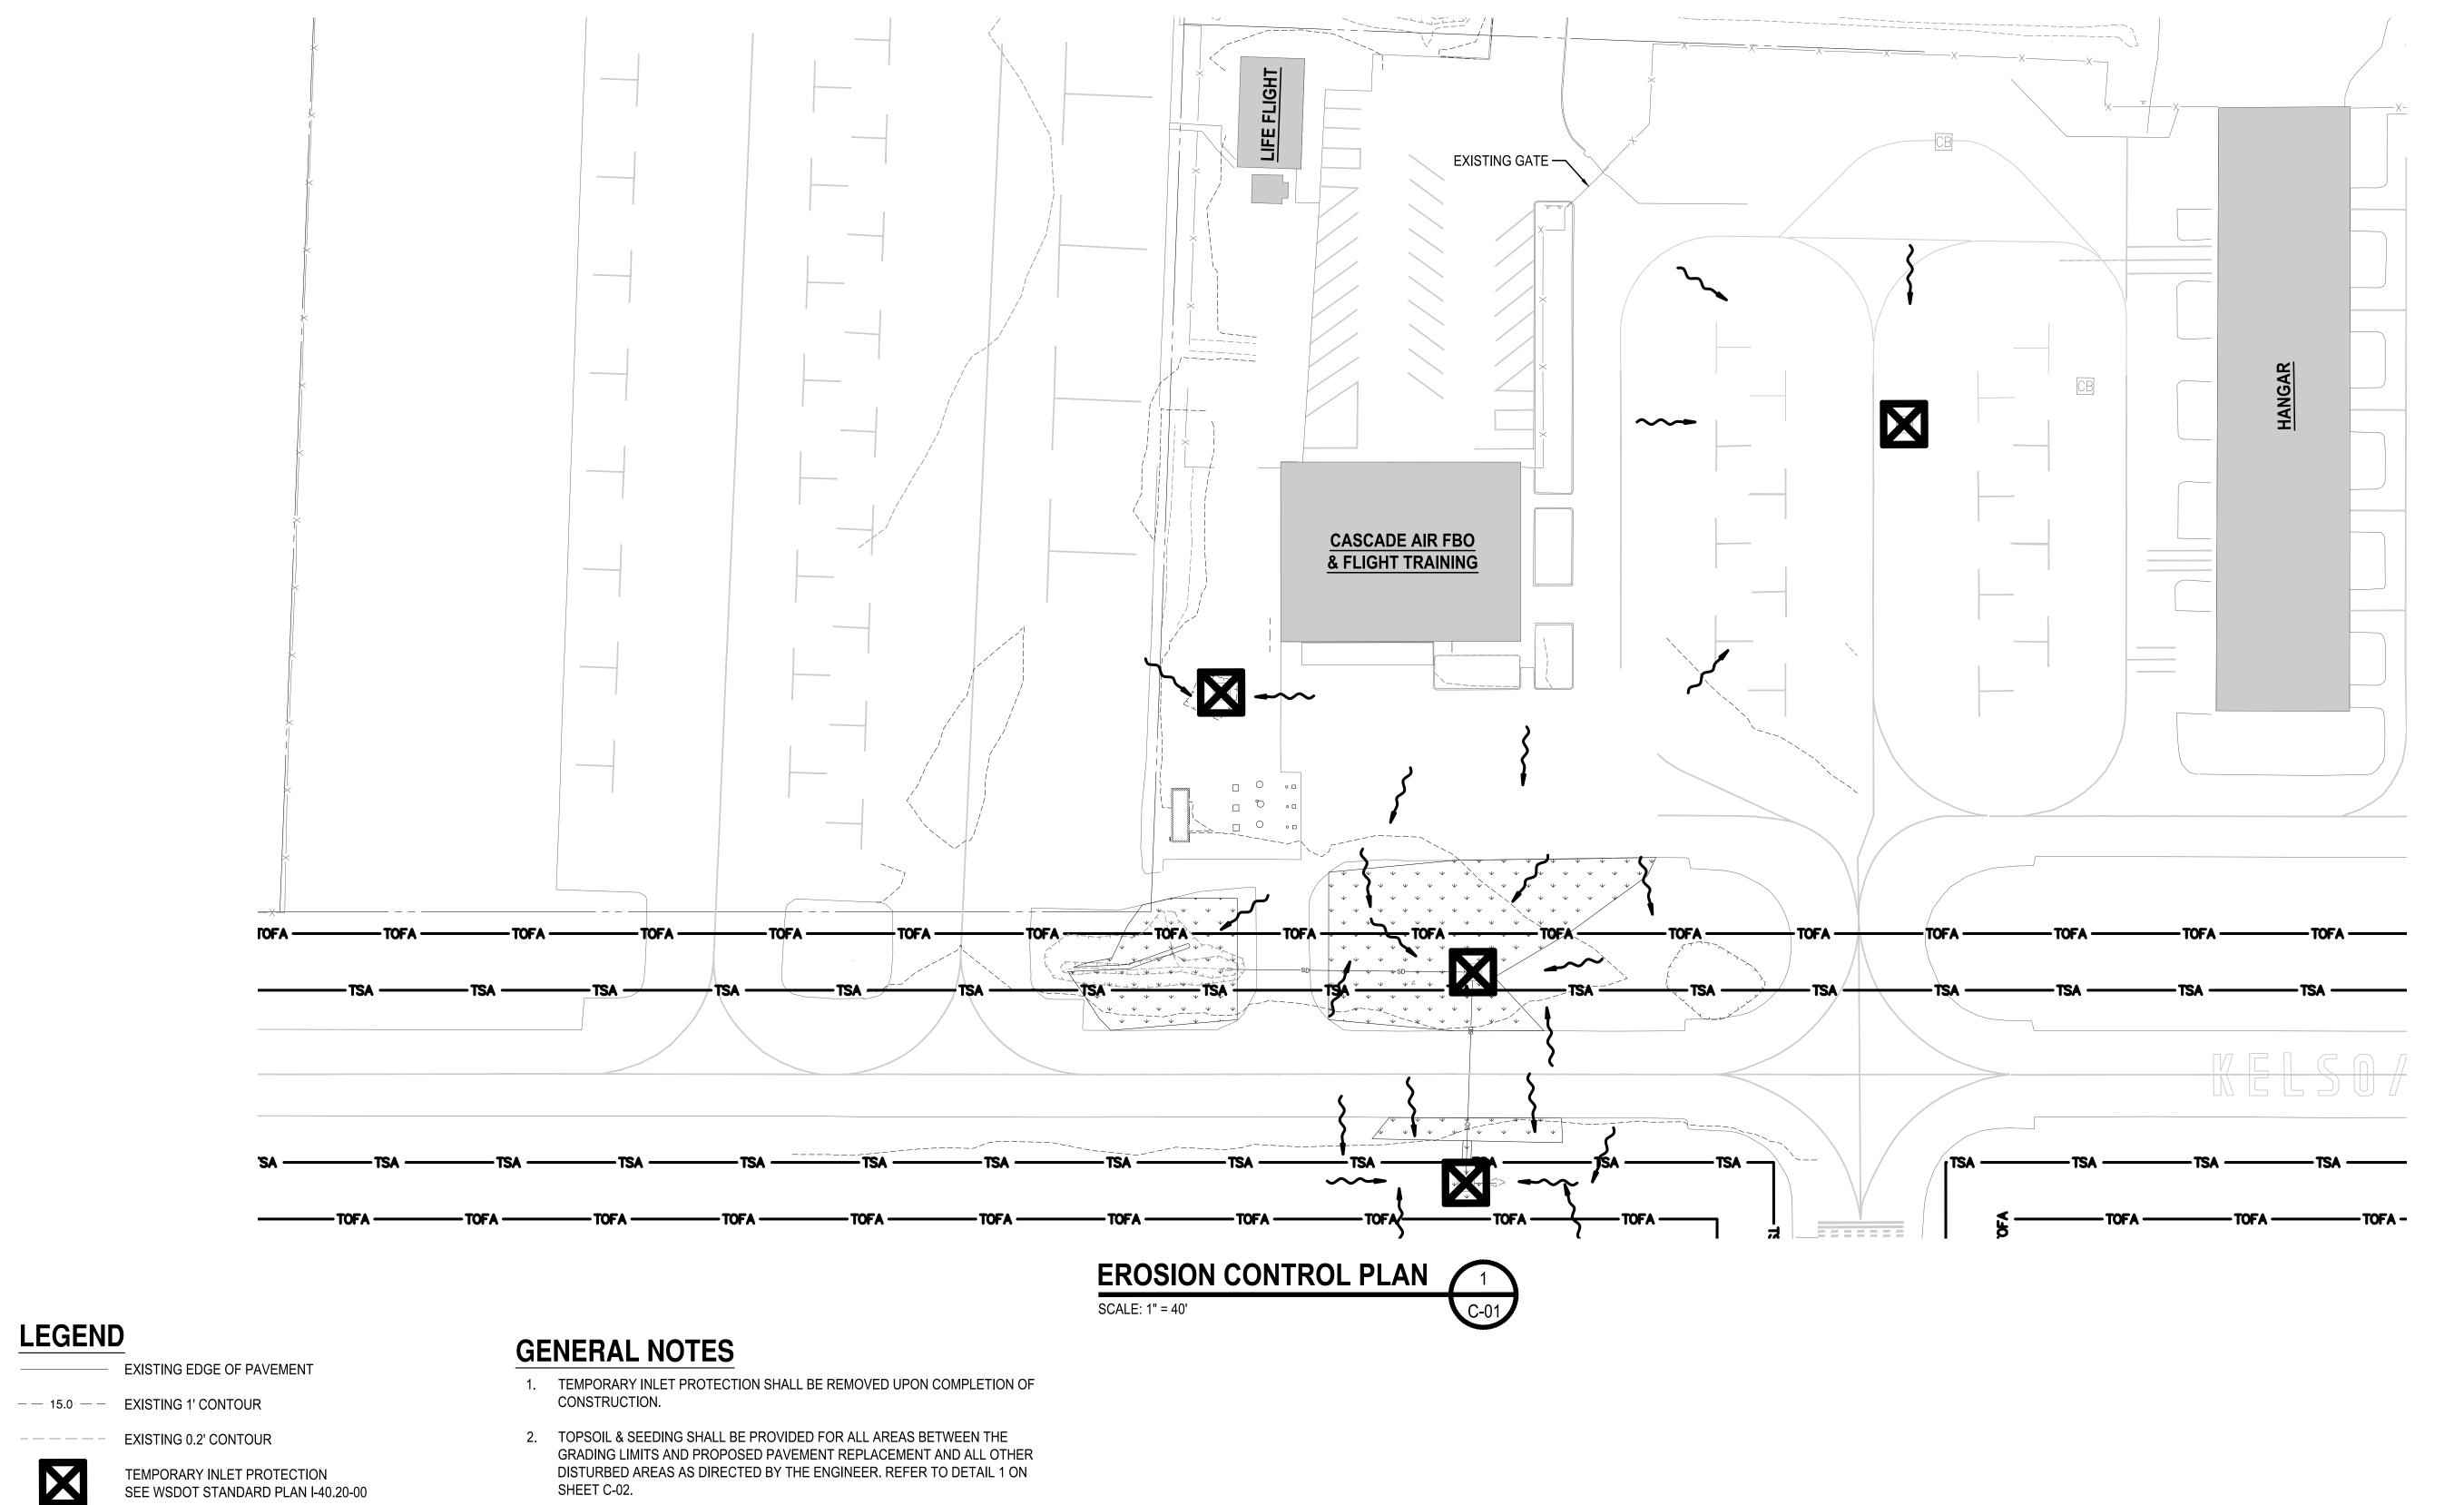

**REVISIONS** 

SEE WSDOT STANDARD PLAN I-40.20-00



TOPSOIL & SEEDING LIMITS, SEE GENERAL NOTE 2.



FLOW DIRECTION

- 3. DO NOT SEED WITHIN SWALE LIMITS (±2").

BOTHELL OFFICE TJS
22232 17TH AVENUE, SUITE 206 DRAWN BY: BOTHELL, WA 98021 ENGINEERING CHECKED BY: CRL DATE: PROJECT NO: SCALE:

35005.004.03

APRIL 2024

DESIGNED BY:

AS NOTED

SOUTHWEST WASHINGTON REGIONAL AIRPORT TASK ORDER #4 - FINAL DESIGN APRON/TAXILANE RECONSTRUCTION

SHEET NO. EROSION CONTROL PLAN 6 OF 15

SCALE OF FEET SCALE= 1"=40'


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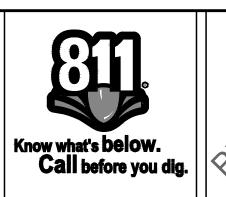




## **EROSION CONTROL GENERAL NOTES**

- 1. ALL EROSION CONTROL DEVICES SHALL BE CONSTRUCTED IN ACCORDANCE WITH THIS EROSION CONTROL PLAN AND THE EROSION CONTROL DETAILS, AND IN PLACE PRIOR TO THE START OF ANY LAND DISTURBING ACTIVITY.
- 2. ALL EROSION PREVENTION AND CONTROL BMP'S SHALL BE INSPECTED, MAINTAINED AND REPAIRED AS NEEDED THROUGHOUT CONSTRUCTION TO ENSURE CONTINUED PERFORMANCE OF THEIR INTENDED FUNCTION.
- 3. PERFORM ALL ACTIONS NECESSARY TO PREVENT EROSION AND CONTROL SEDIMENT, INCLUDING DUST, FROM LEAVING THE CONSTRUCTION SITE.
- 4. AS CONSTRUCTION PROGRESSES AND SEASONAL CONDITIONS DICTATE, MORE EROSION AND SEDIMENT CONTROLS MAY BE REQUIRED TO ENSURE THAT SEDIMENT AND SEDIMENT-LADEN WATERS DO NOT ENTER THE DRAINAGE SYSTEM, ROADWAYS, OR SURFACE WATERS.



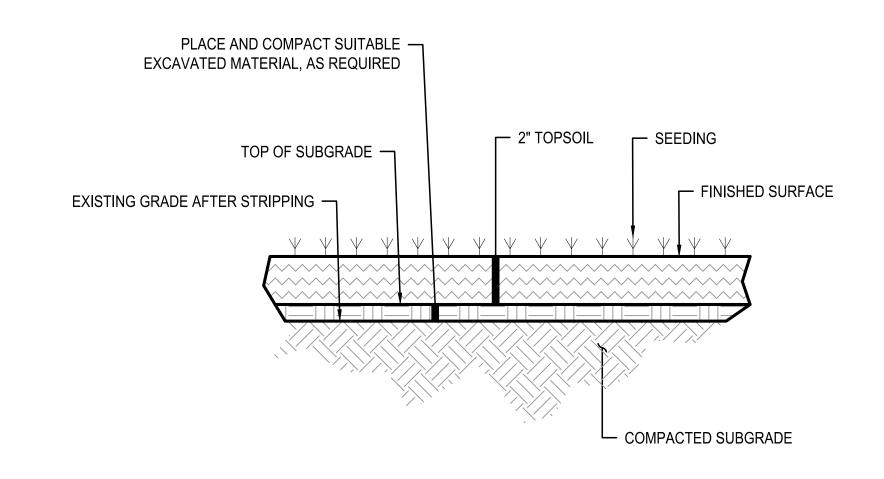



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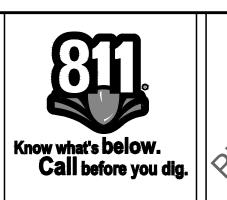
CENTURY WEST ENGINEERING	BOTHELL, WA 98021 425.286.6602	DESIGNED BY: TJS  DRAWN BY: TJS  CHECKED BY: CRL
DATE:	PROJECT NO:	SCALE:
APRIL 2024	35005.004.03	AS NOTED

SOUTHWEST WASHINGTON REGIONAL AIRPORT	DRAWING NO.	
TASK ORDER #4 - FINAL DESIGN	C-02	
APRON/TAXILANE RECONSTRUCTION		
	SHEET NO.	
EROSION CONTROL NOTES AND DETAILS	7 OF 15	





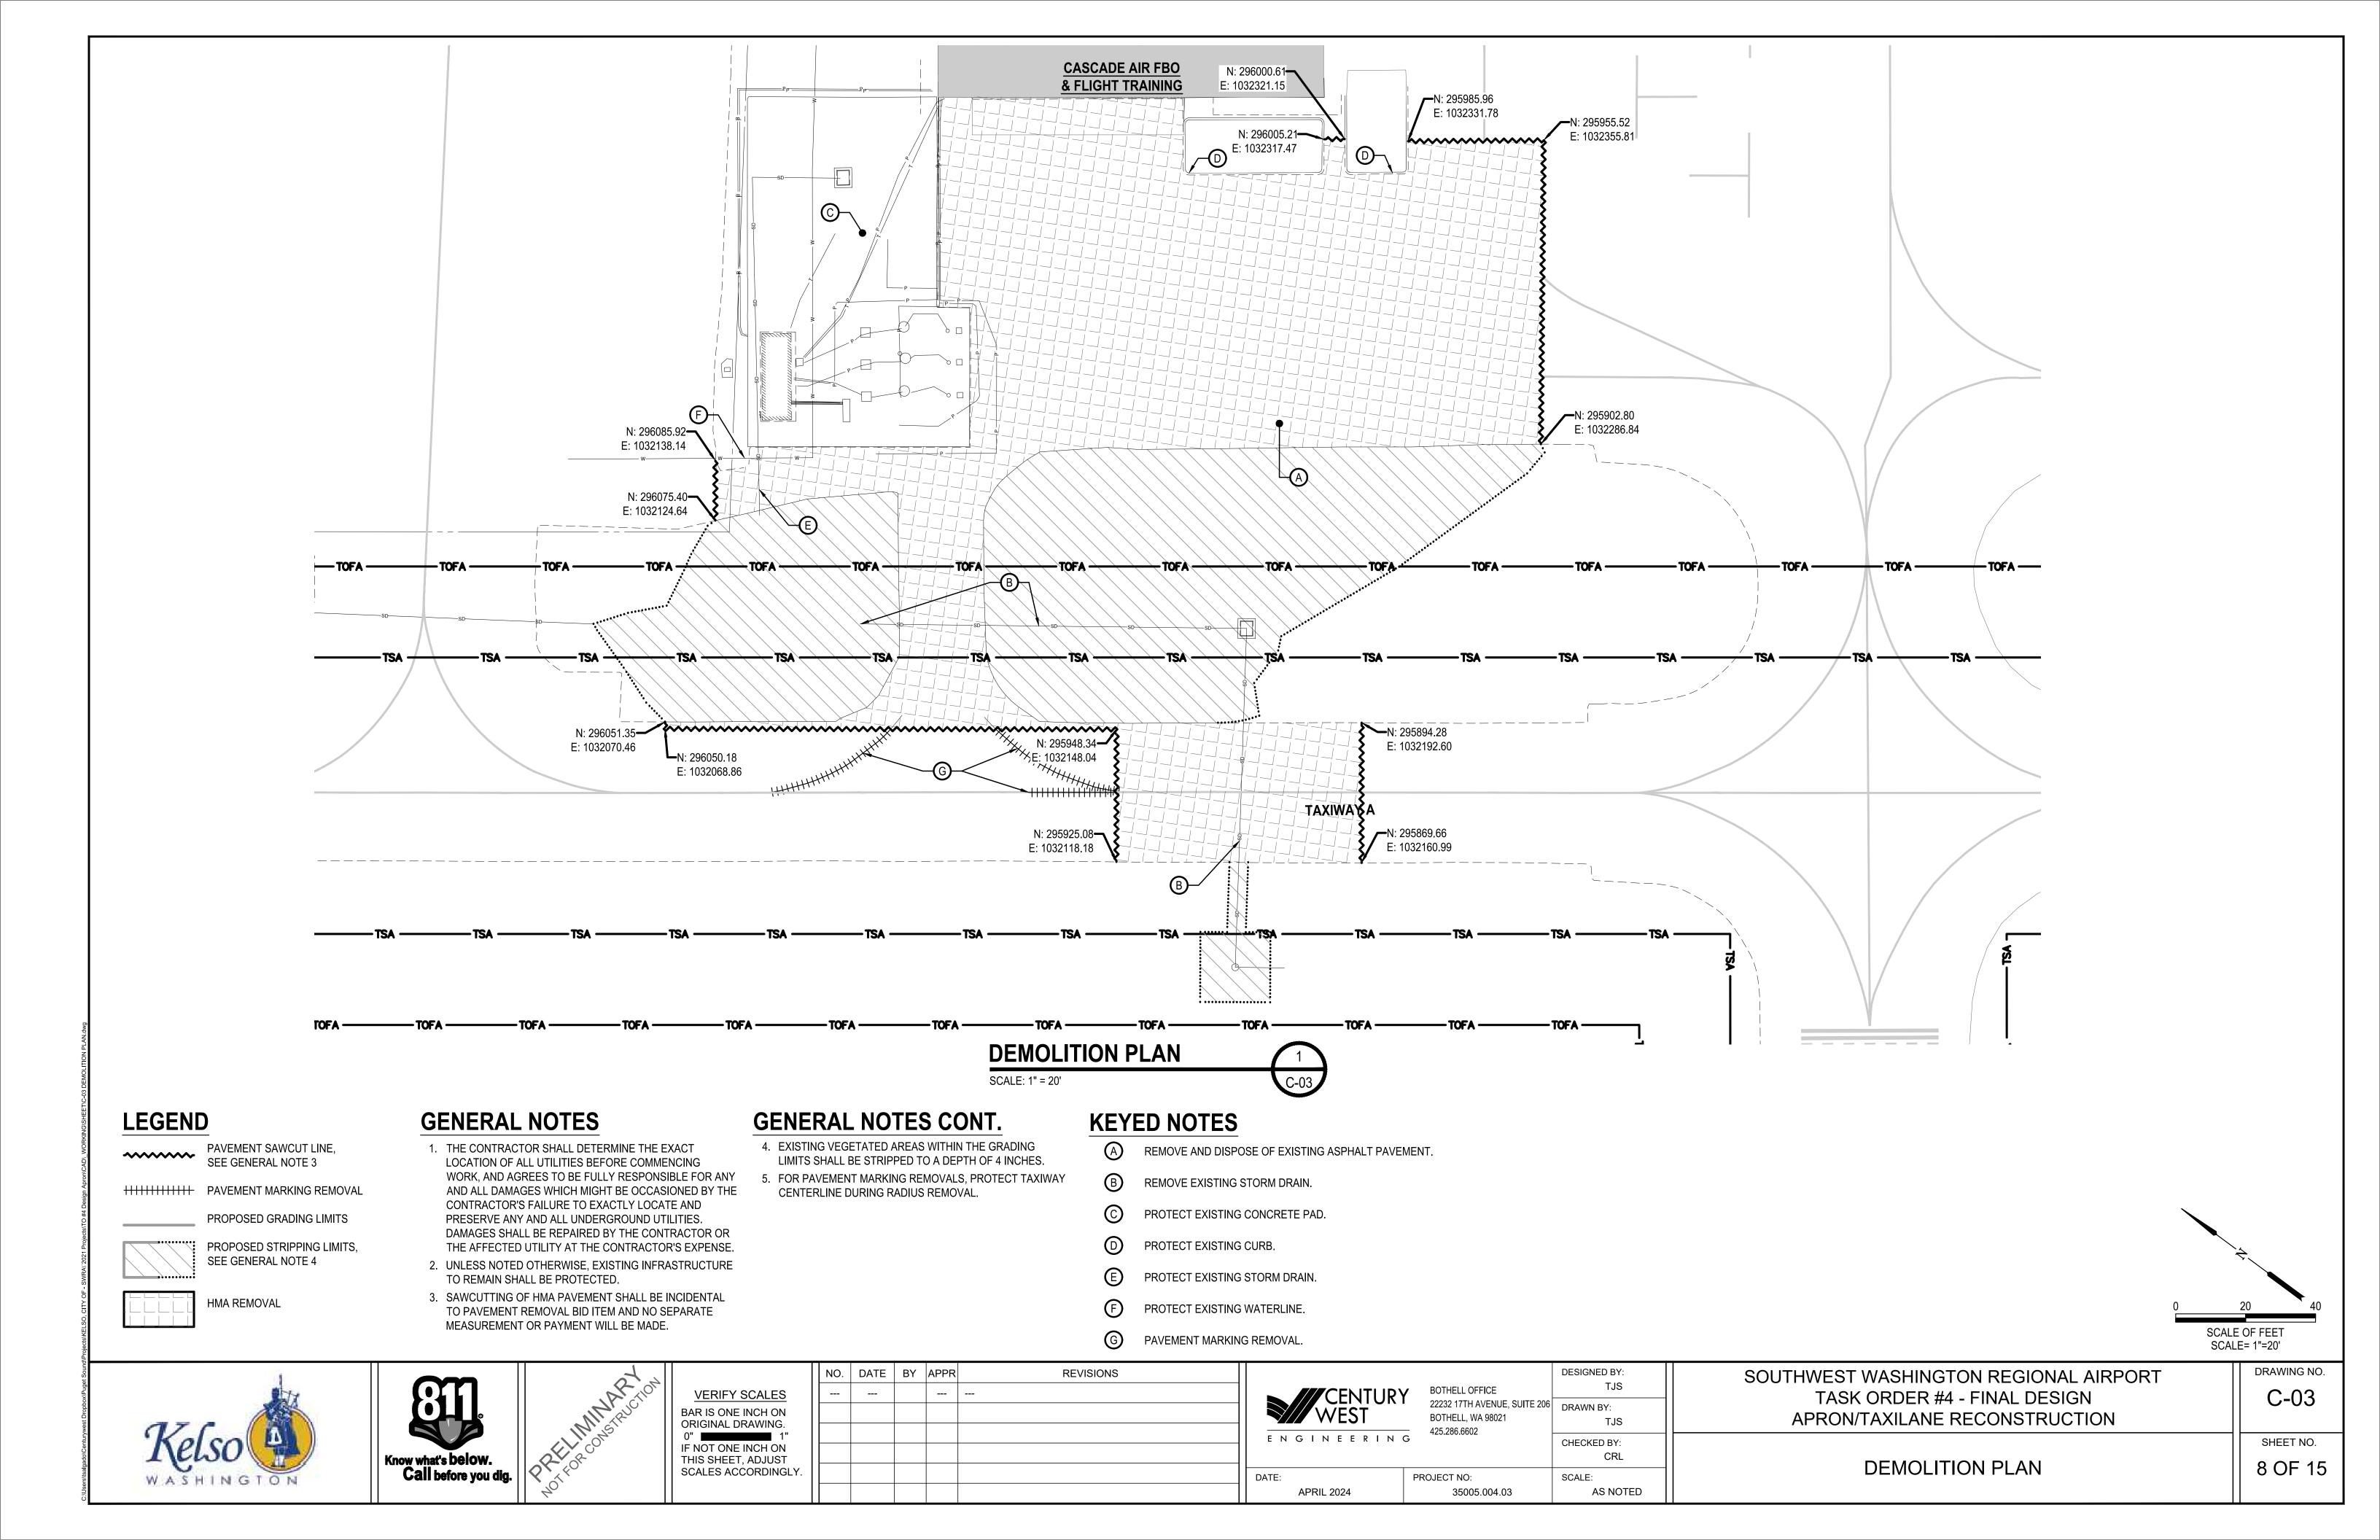

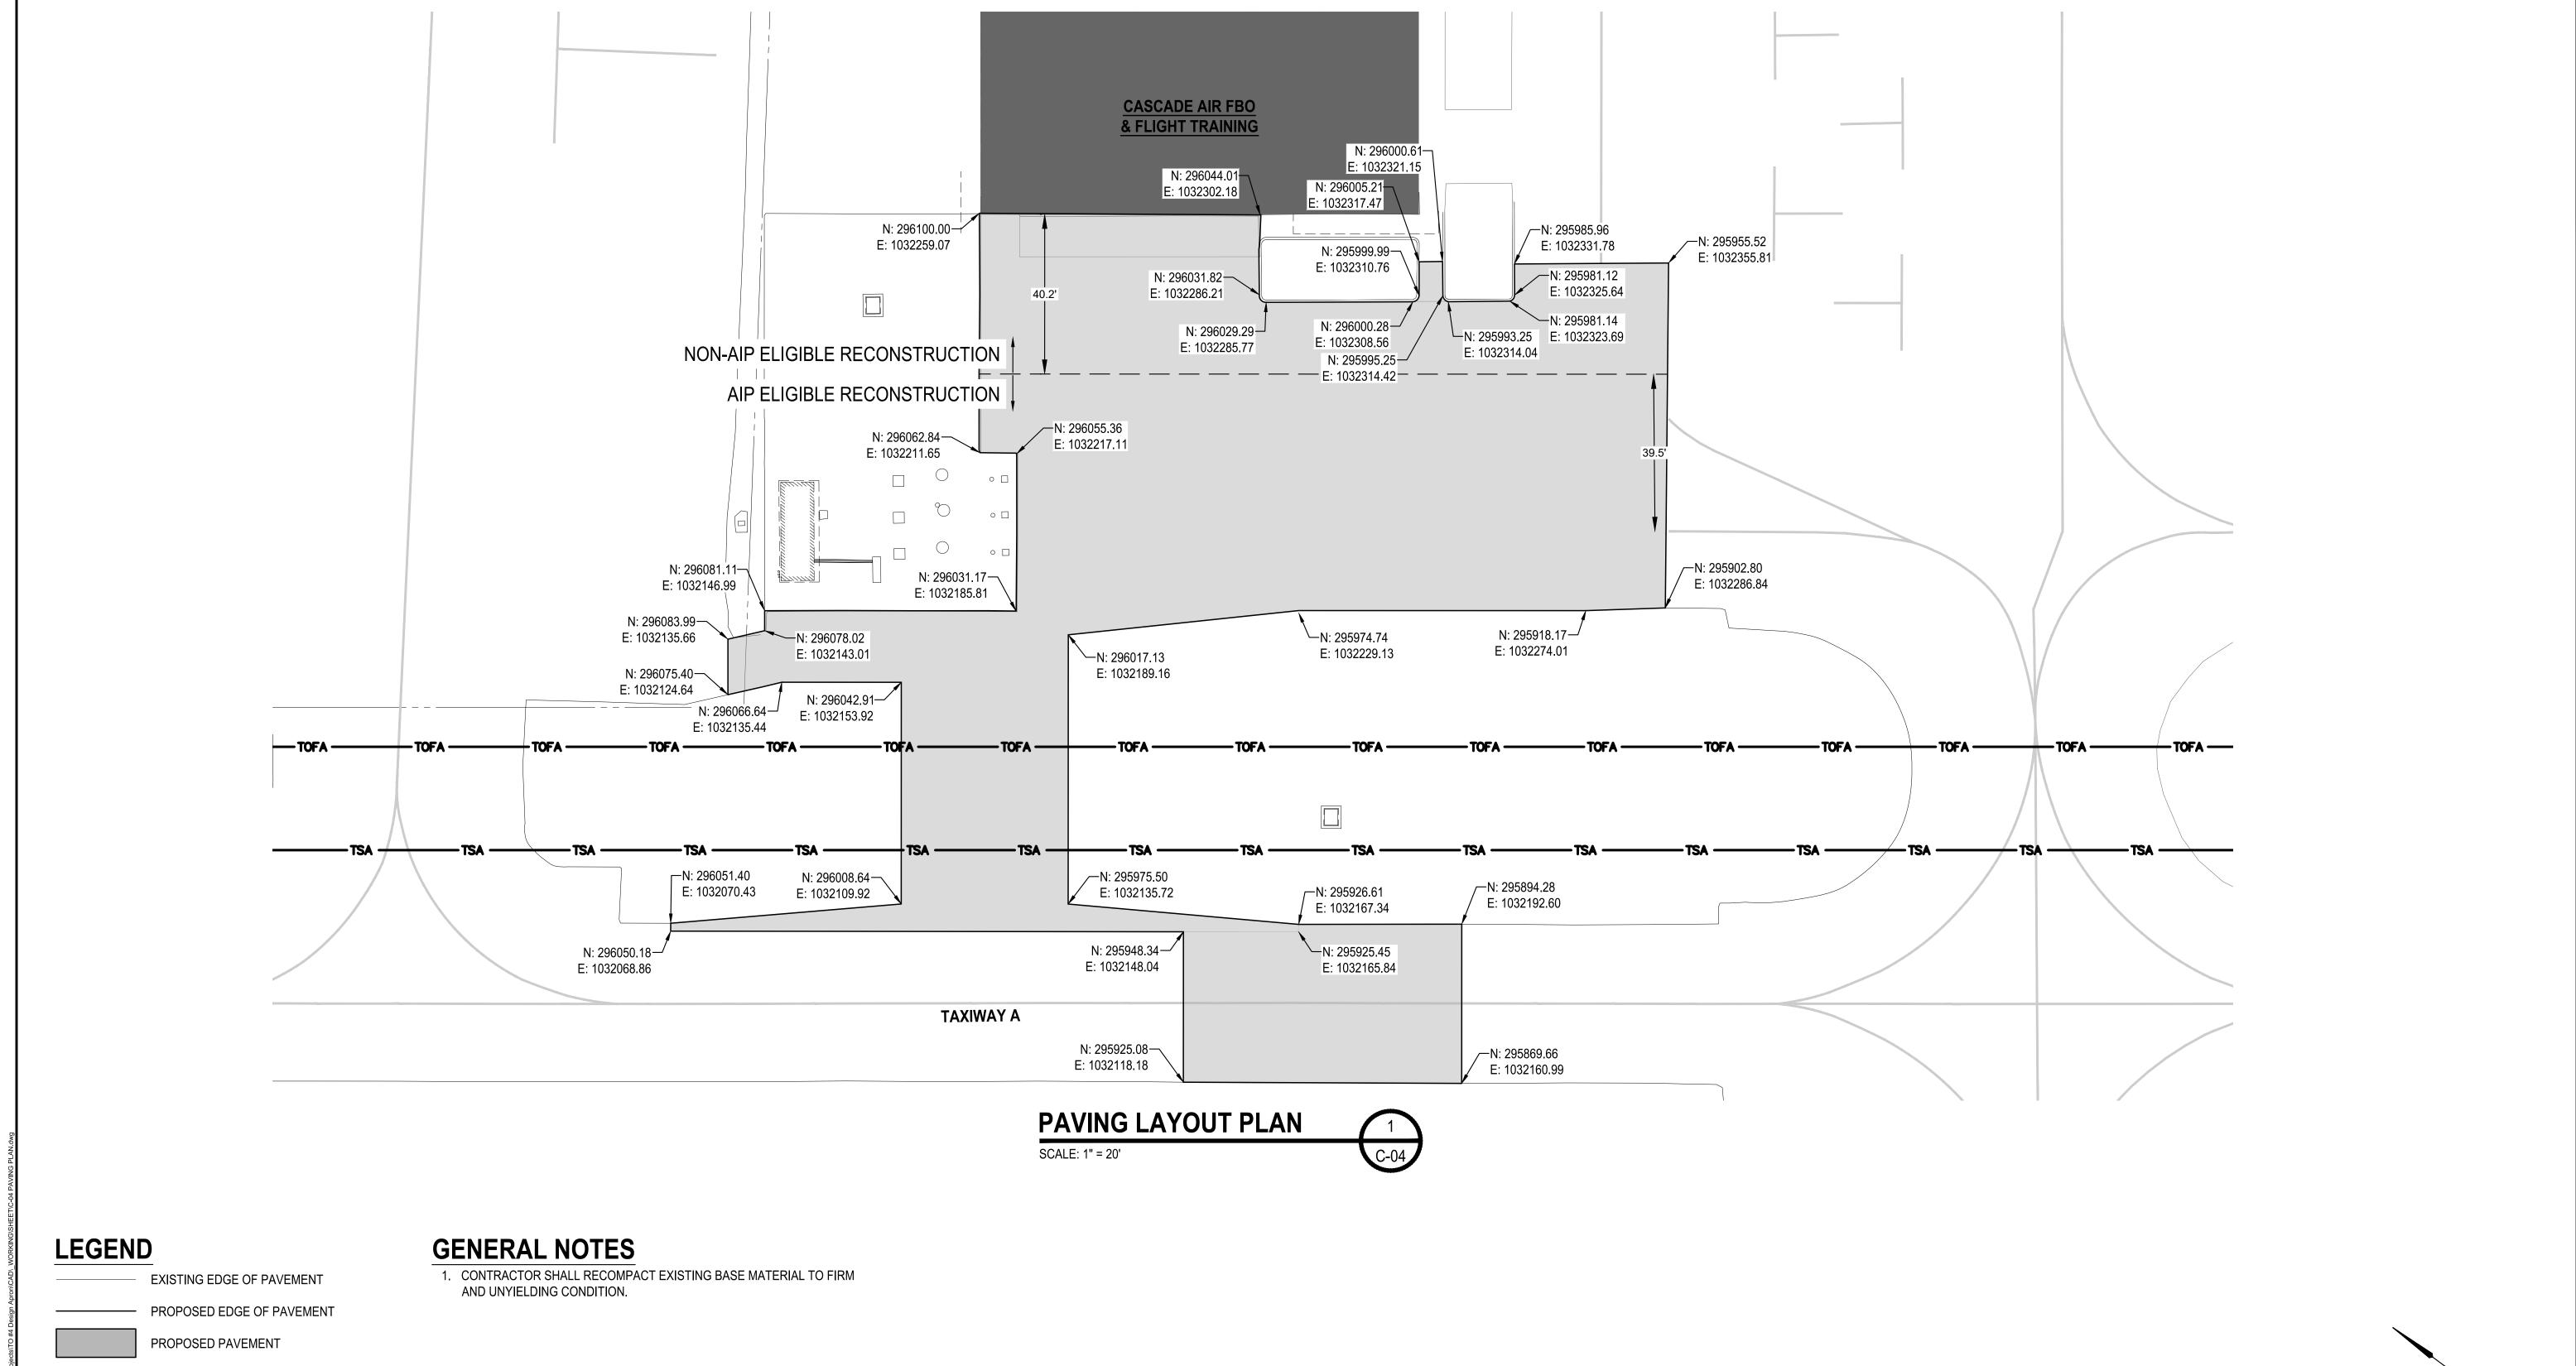

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CENTURY WEST	_
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APRIL 2024	

**REVISIONS** 

BOTHELL OFFICE	DESIGNED BY: TJS	
22232 17TH AVENUE, SUITE 206 BOTHELL, WA 98021 425.286.6602	DRAWN BY: TJS	
20.200.0002	CHECKED BY: CRL	
ROJECT NO: 35005.004.03	SCALE: AS NOTED	


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TASK ORDER #4 - FINAL DESIGN	
APRON/TAXILANE RECONSTRUCTION	
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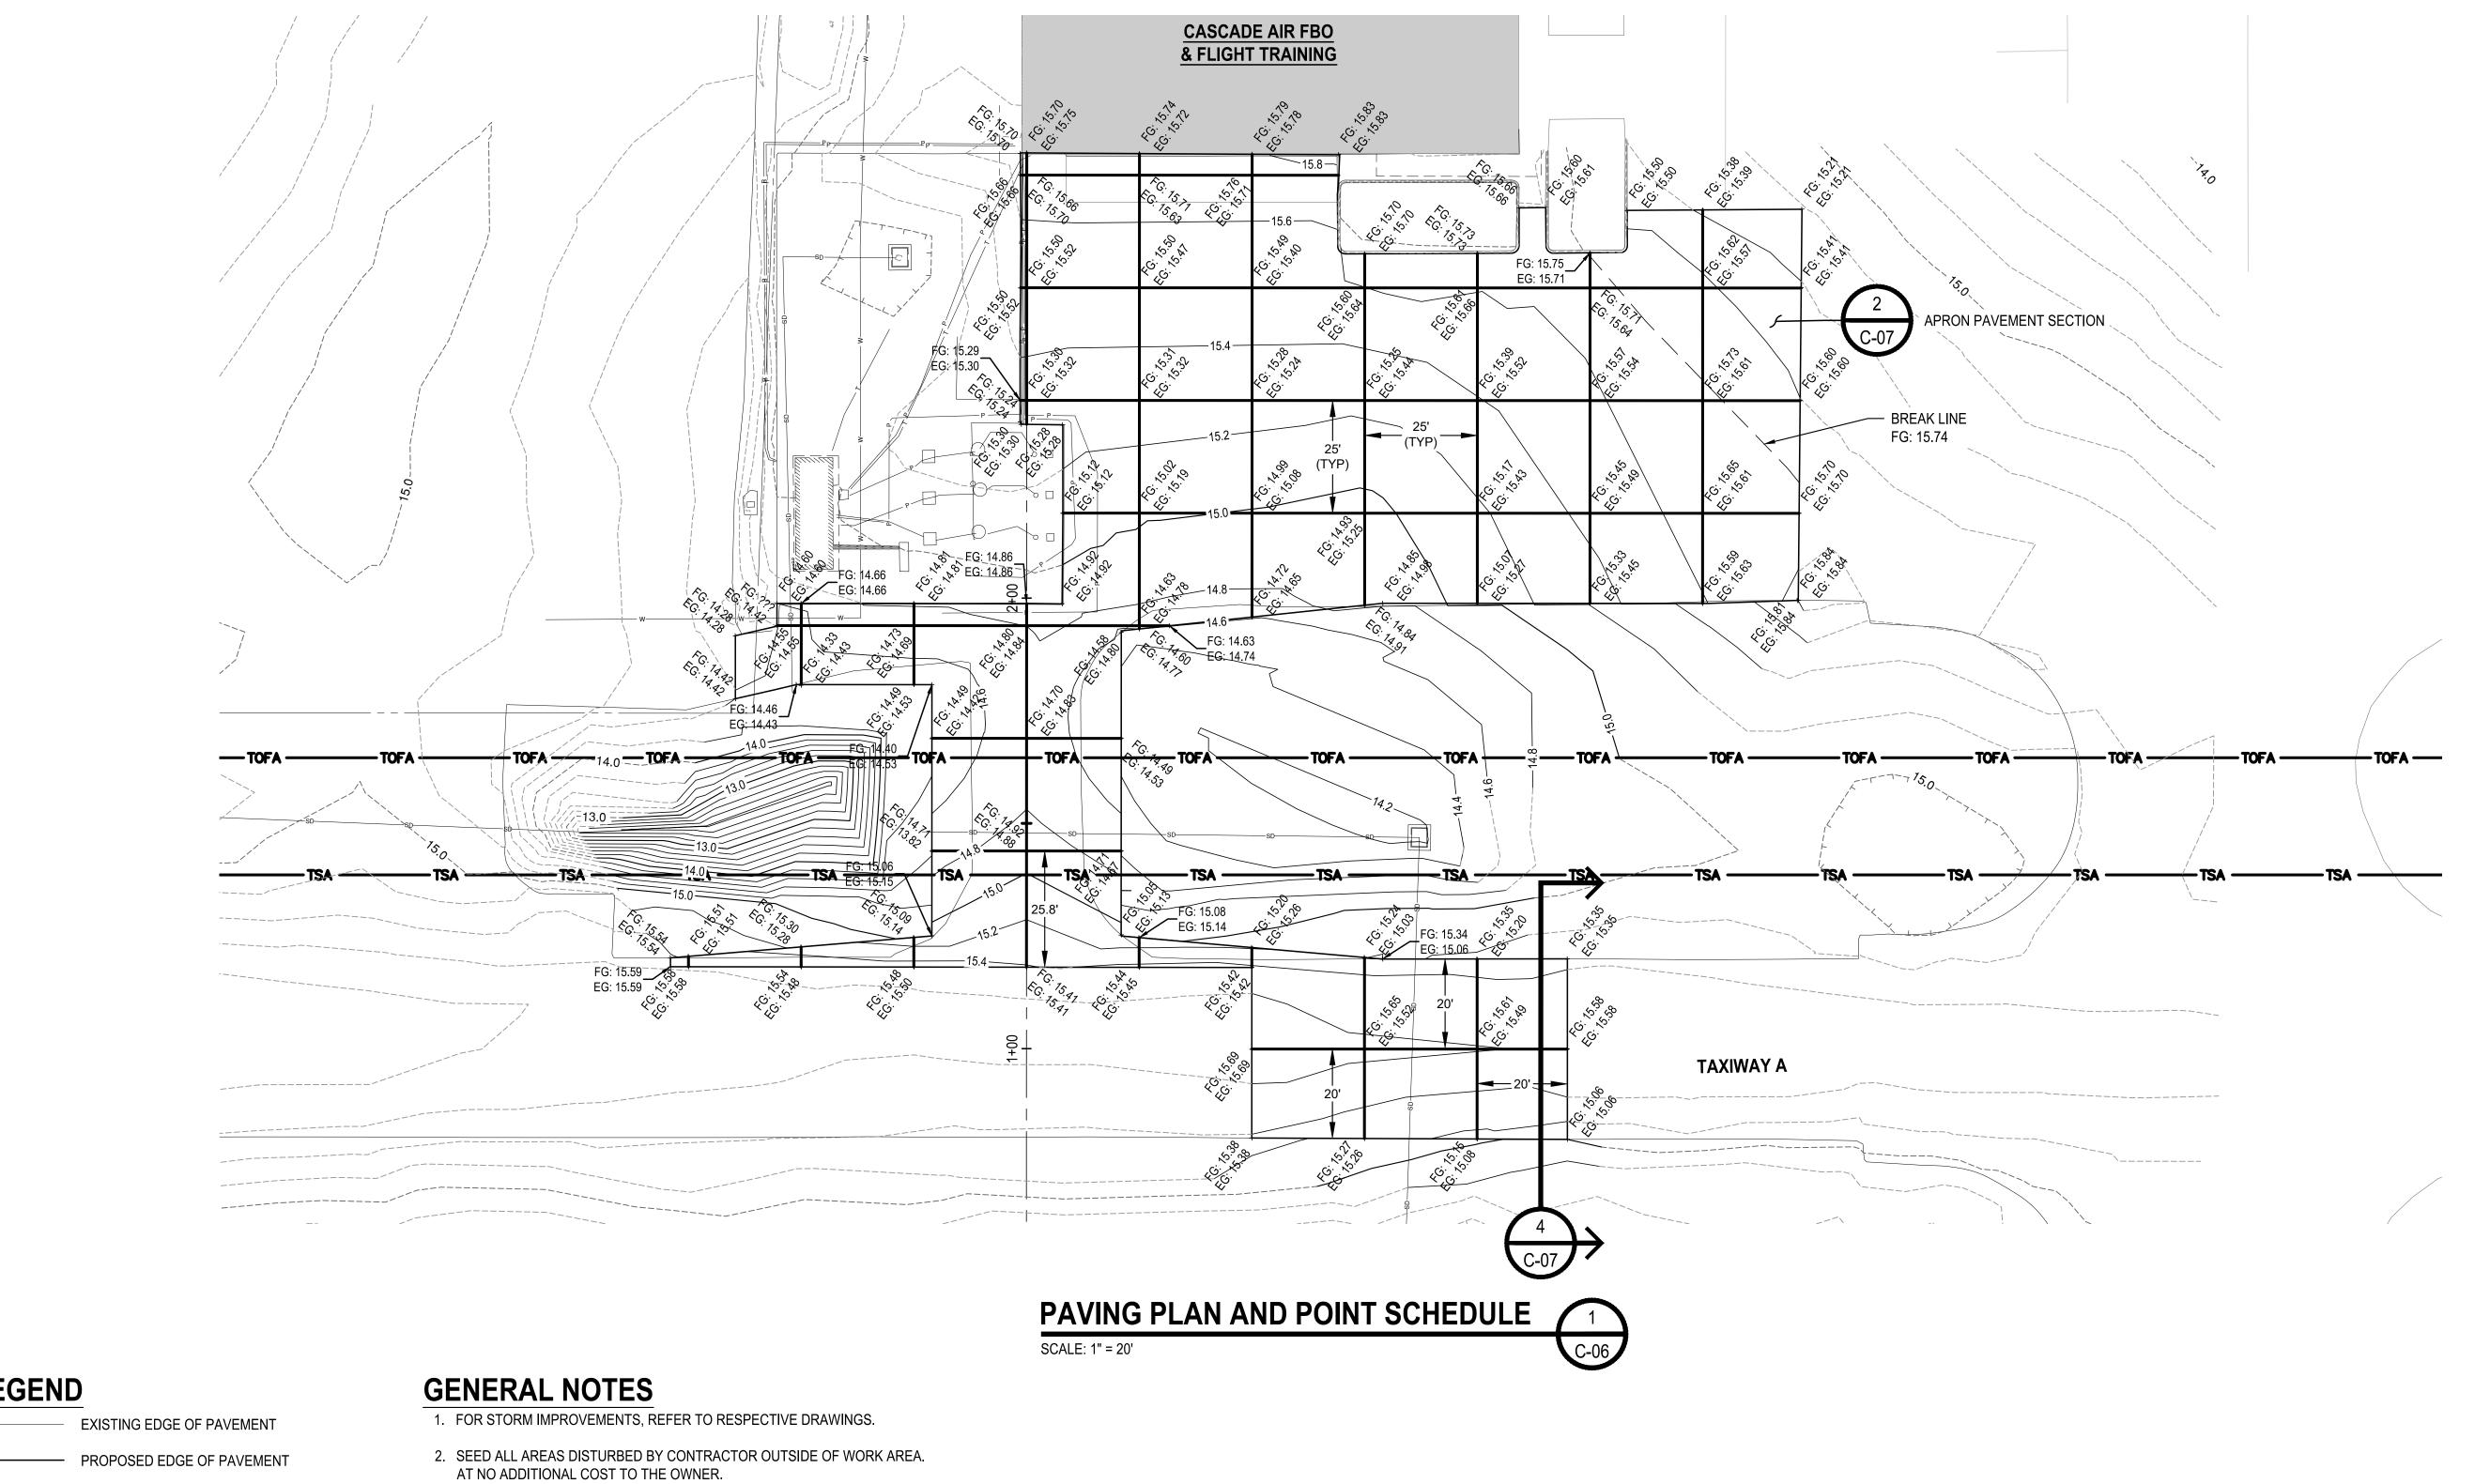
SHEET NO. PAVING LAYOUT PLAN

SCALE OF FEET SCALE= 1"=20'

DRAWING NO. C-04

9 OF 15



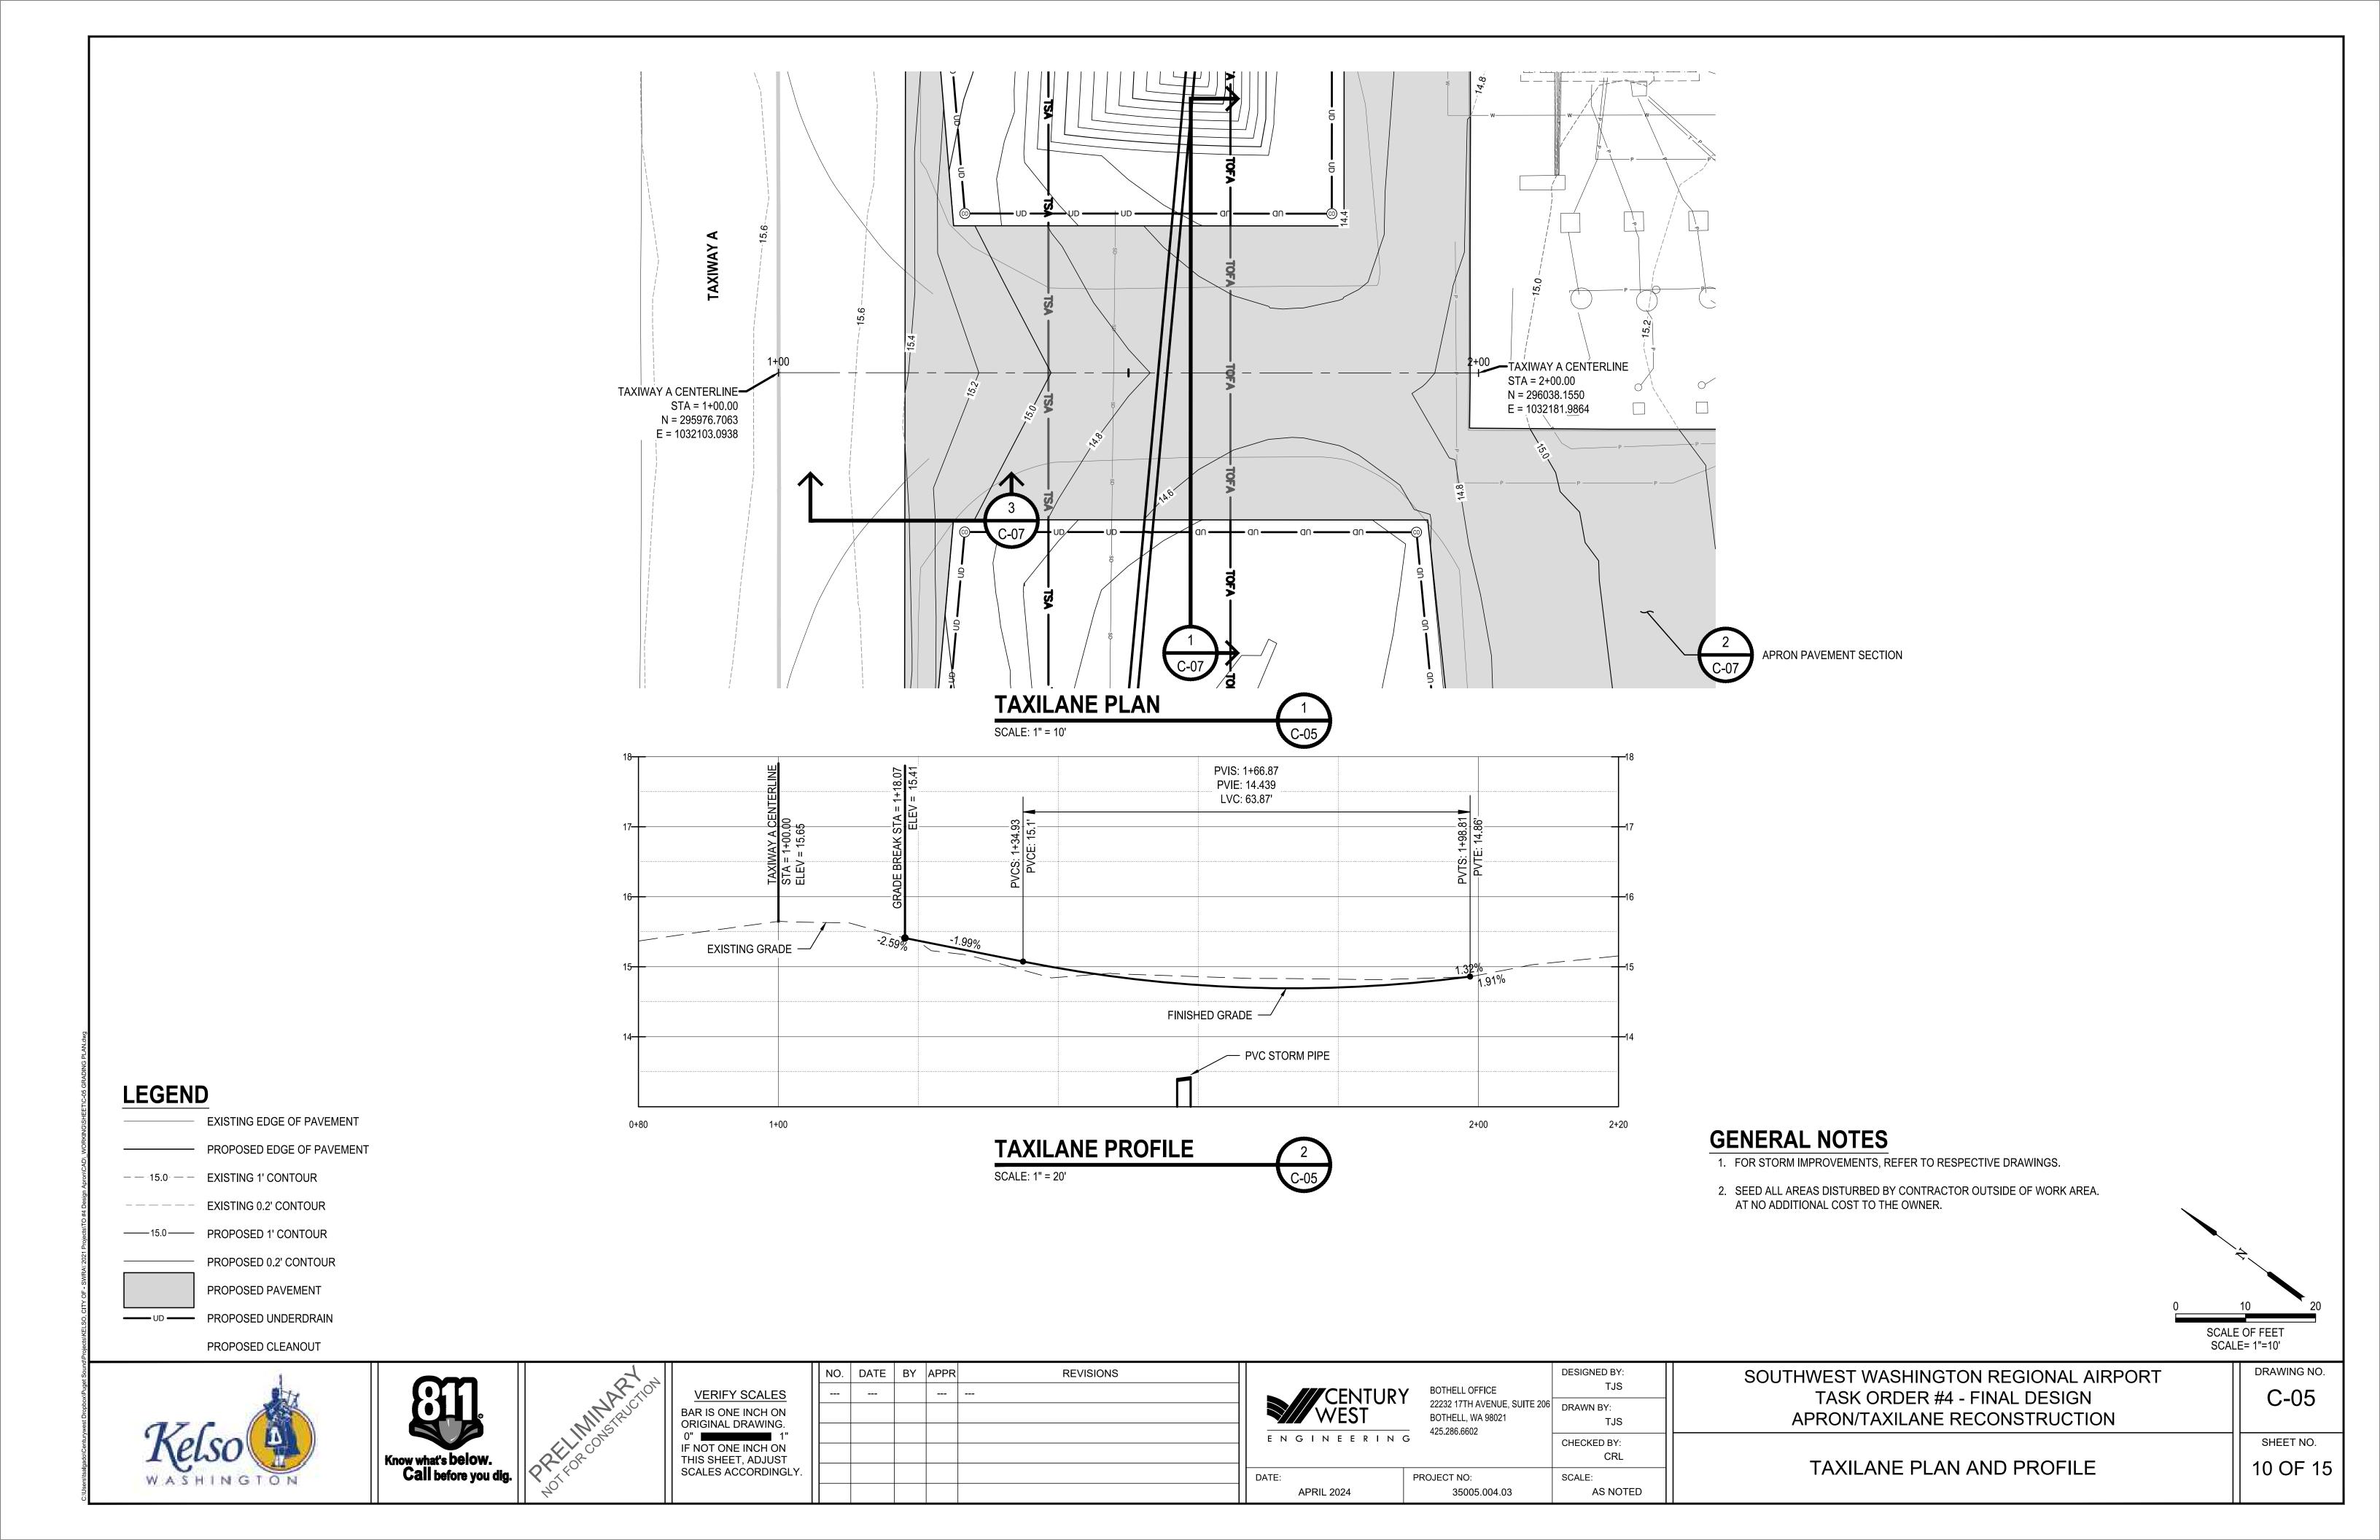

## **LEGEND**

- - 15.0 - - EXISTING 1' CONTOUR

---- EXISTING 0.2' CONTOUR

——15.0—— PROPOSED 1' CONTOUR PROPOSED 0.2' CONTOUR







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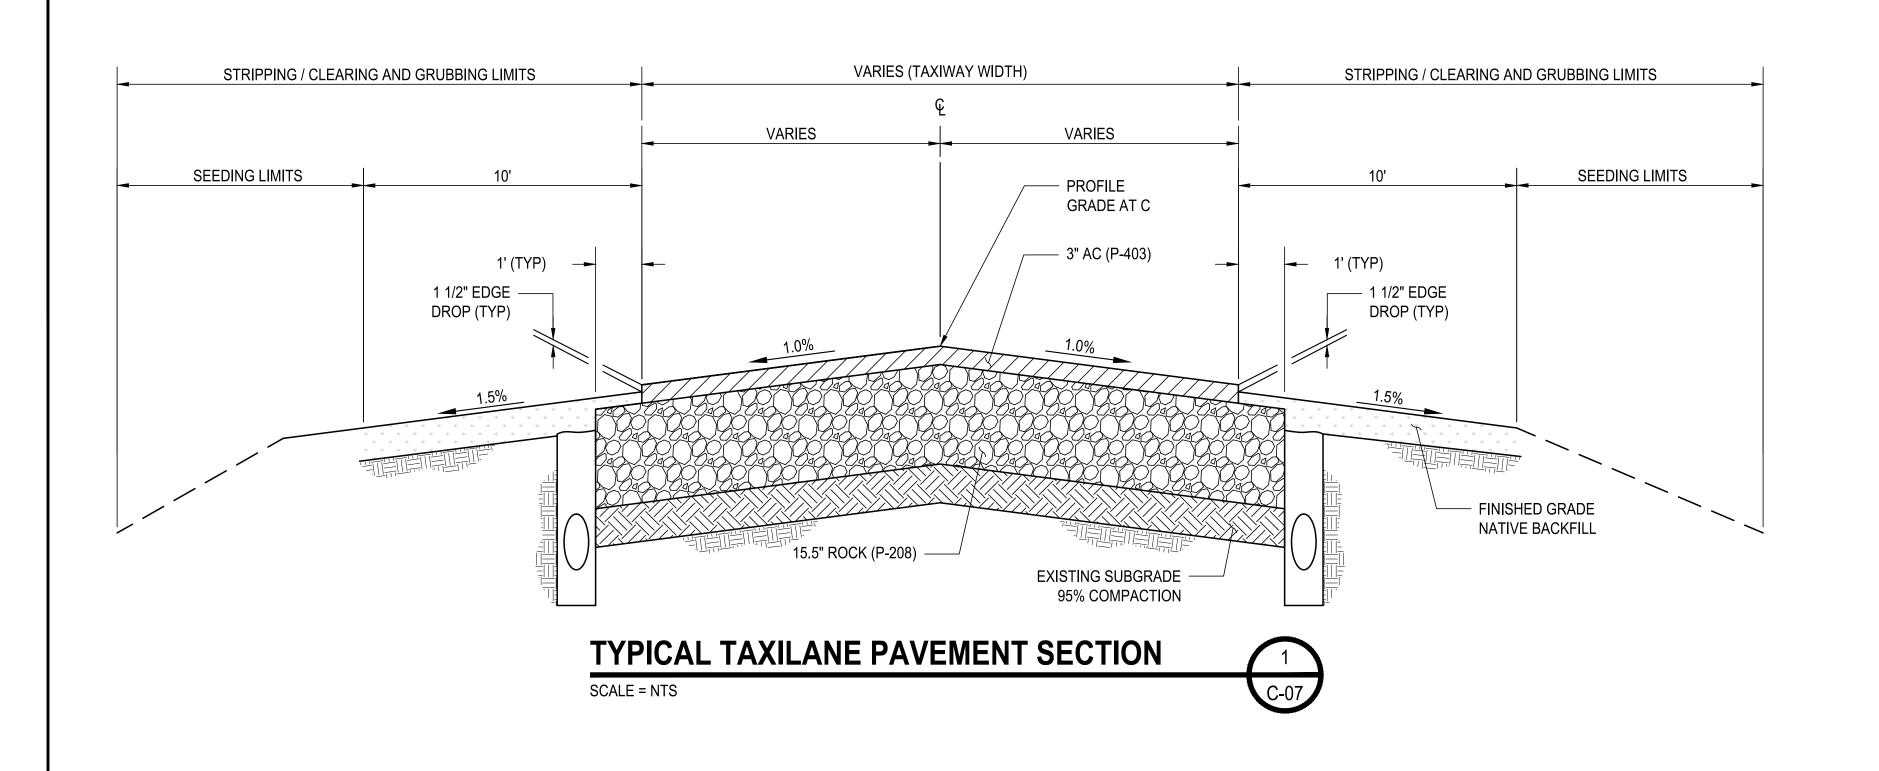
REVISIONS	CENTURY  WEST  BOTHELL OFFICE  22232 17TH AVENUE, SUITE 200  BOTHELL, WA 98021  425.286.6602	BOTHELL OFFICE	DESIGNED BY: TJS
		BOTHELL, WA 98021	DRAWN BY: TJS
		CHECKED BY: CRL	
	DATE: APRIL 2024	PROJECT NO: 35005.004.03	SCALE: AS NOTED


SOUTHWEST WASHINGTON REGIONAL AIRPORT	
TASK ORDER #4 - FINAL DESIGN	
APRON/TAXILANE RECONSTRUCTION	
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PAVING PLAN AND POINT SCHEDULE

C-06


SHEET NO. 11 OF 15



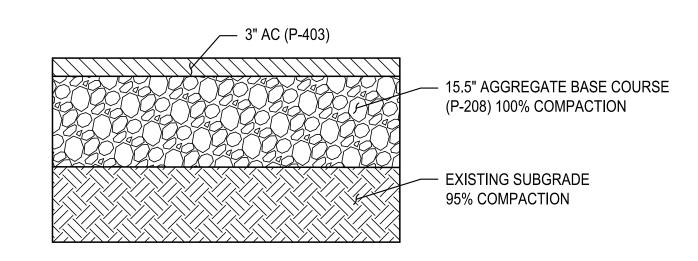

TYPICAL PAVMENT SECTION APRON


2 C-07

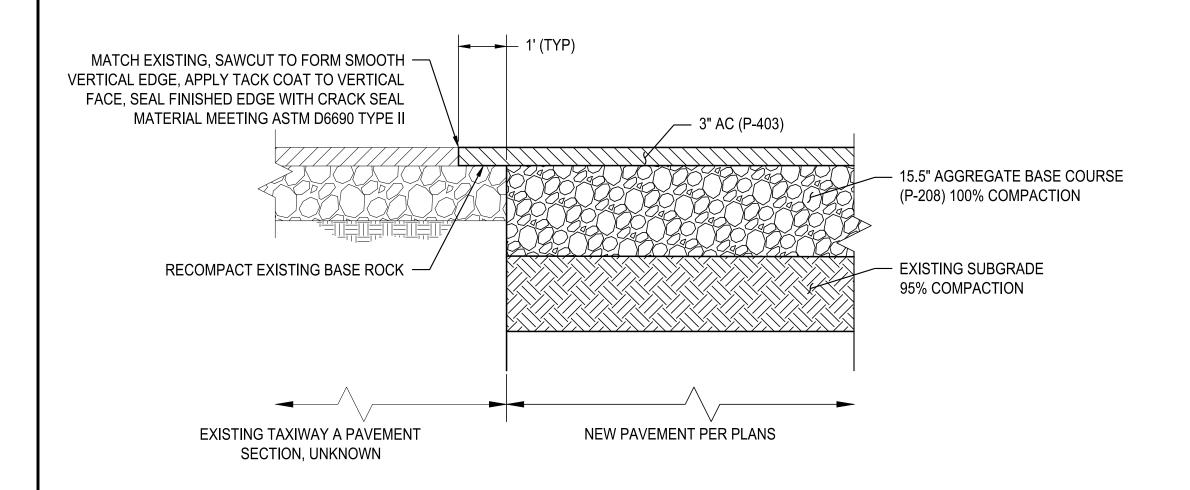

TYPICAL CONNECTION TO EXISTING PAVEMENT

SCALE = NTS

3
C-0

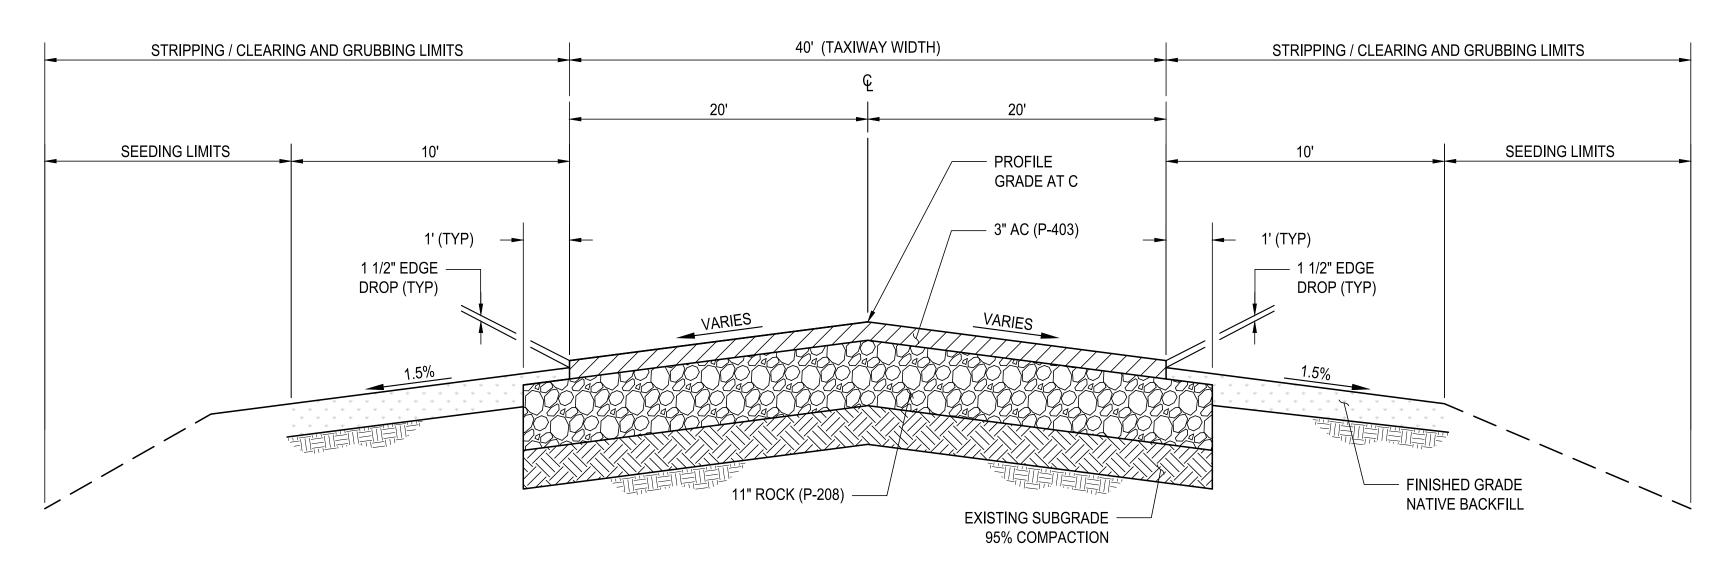

SCALE = NTS

**TAXIWAY A SECTION** 

1ON 4 C-07

- NOTES:
- CLEARING, GRUBBING LIMITS EXTEND FROM EXISTING EDGE OF PAVEMENT TO NEW CUT/FILL LIMITS.
  - 2. ALL COMPACTION REQUIREMENTS PER ASTM D-698 UNLESS NOTED OTHERWISE.
  - 3. EXCAVATION DEPTH TO REACH SUITABLE MATERIAL OR 18", WHICHEVER IS LESS. DEPTH AND LIMITS ARE TO BE DETERMINED IN THE FIELD BY THE ENGINEER.

DRAWING NO.

C-07





2 RELIMITARY TO STRUCTION OF THE PROPERTY OF T

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DESIGNED BY:
TJS

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TJS

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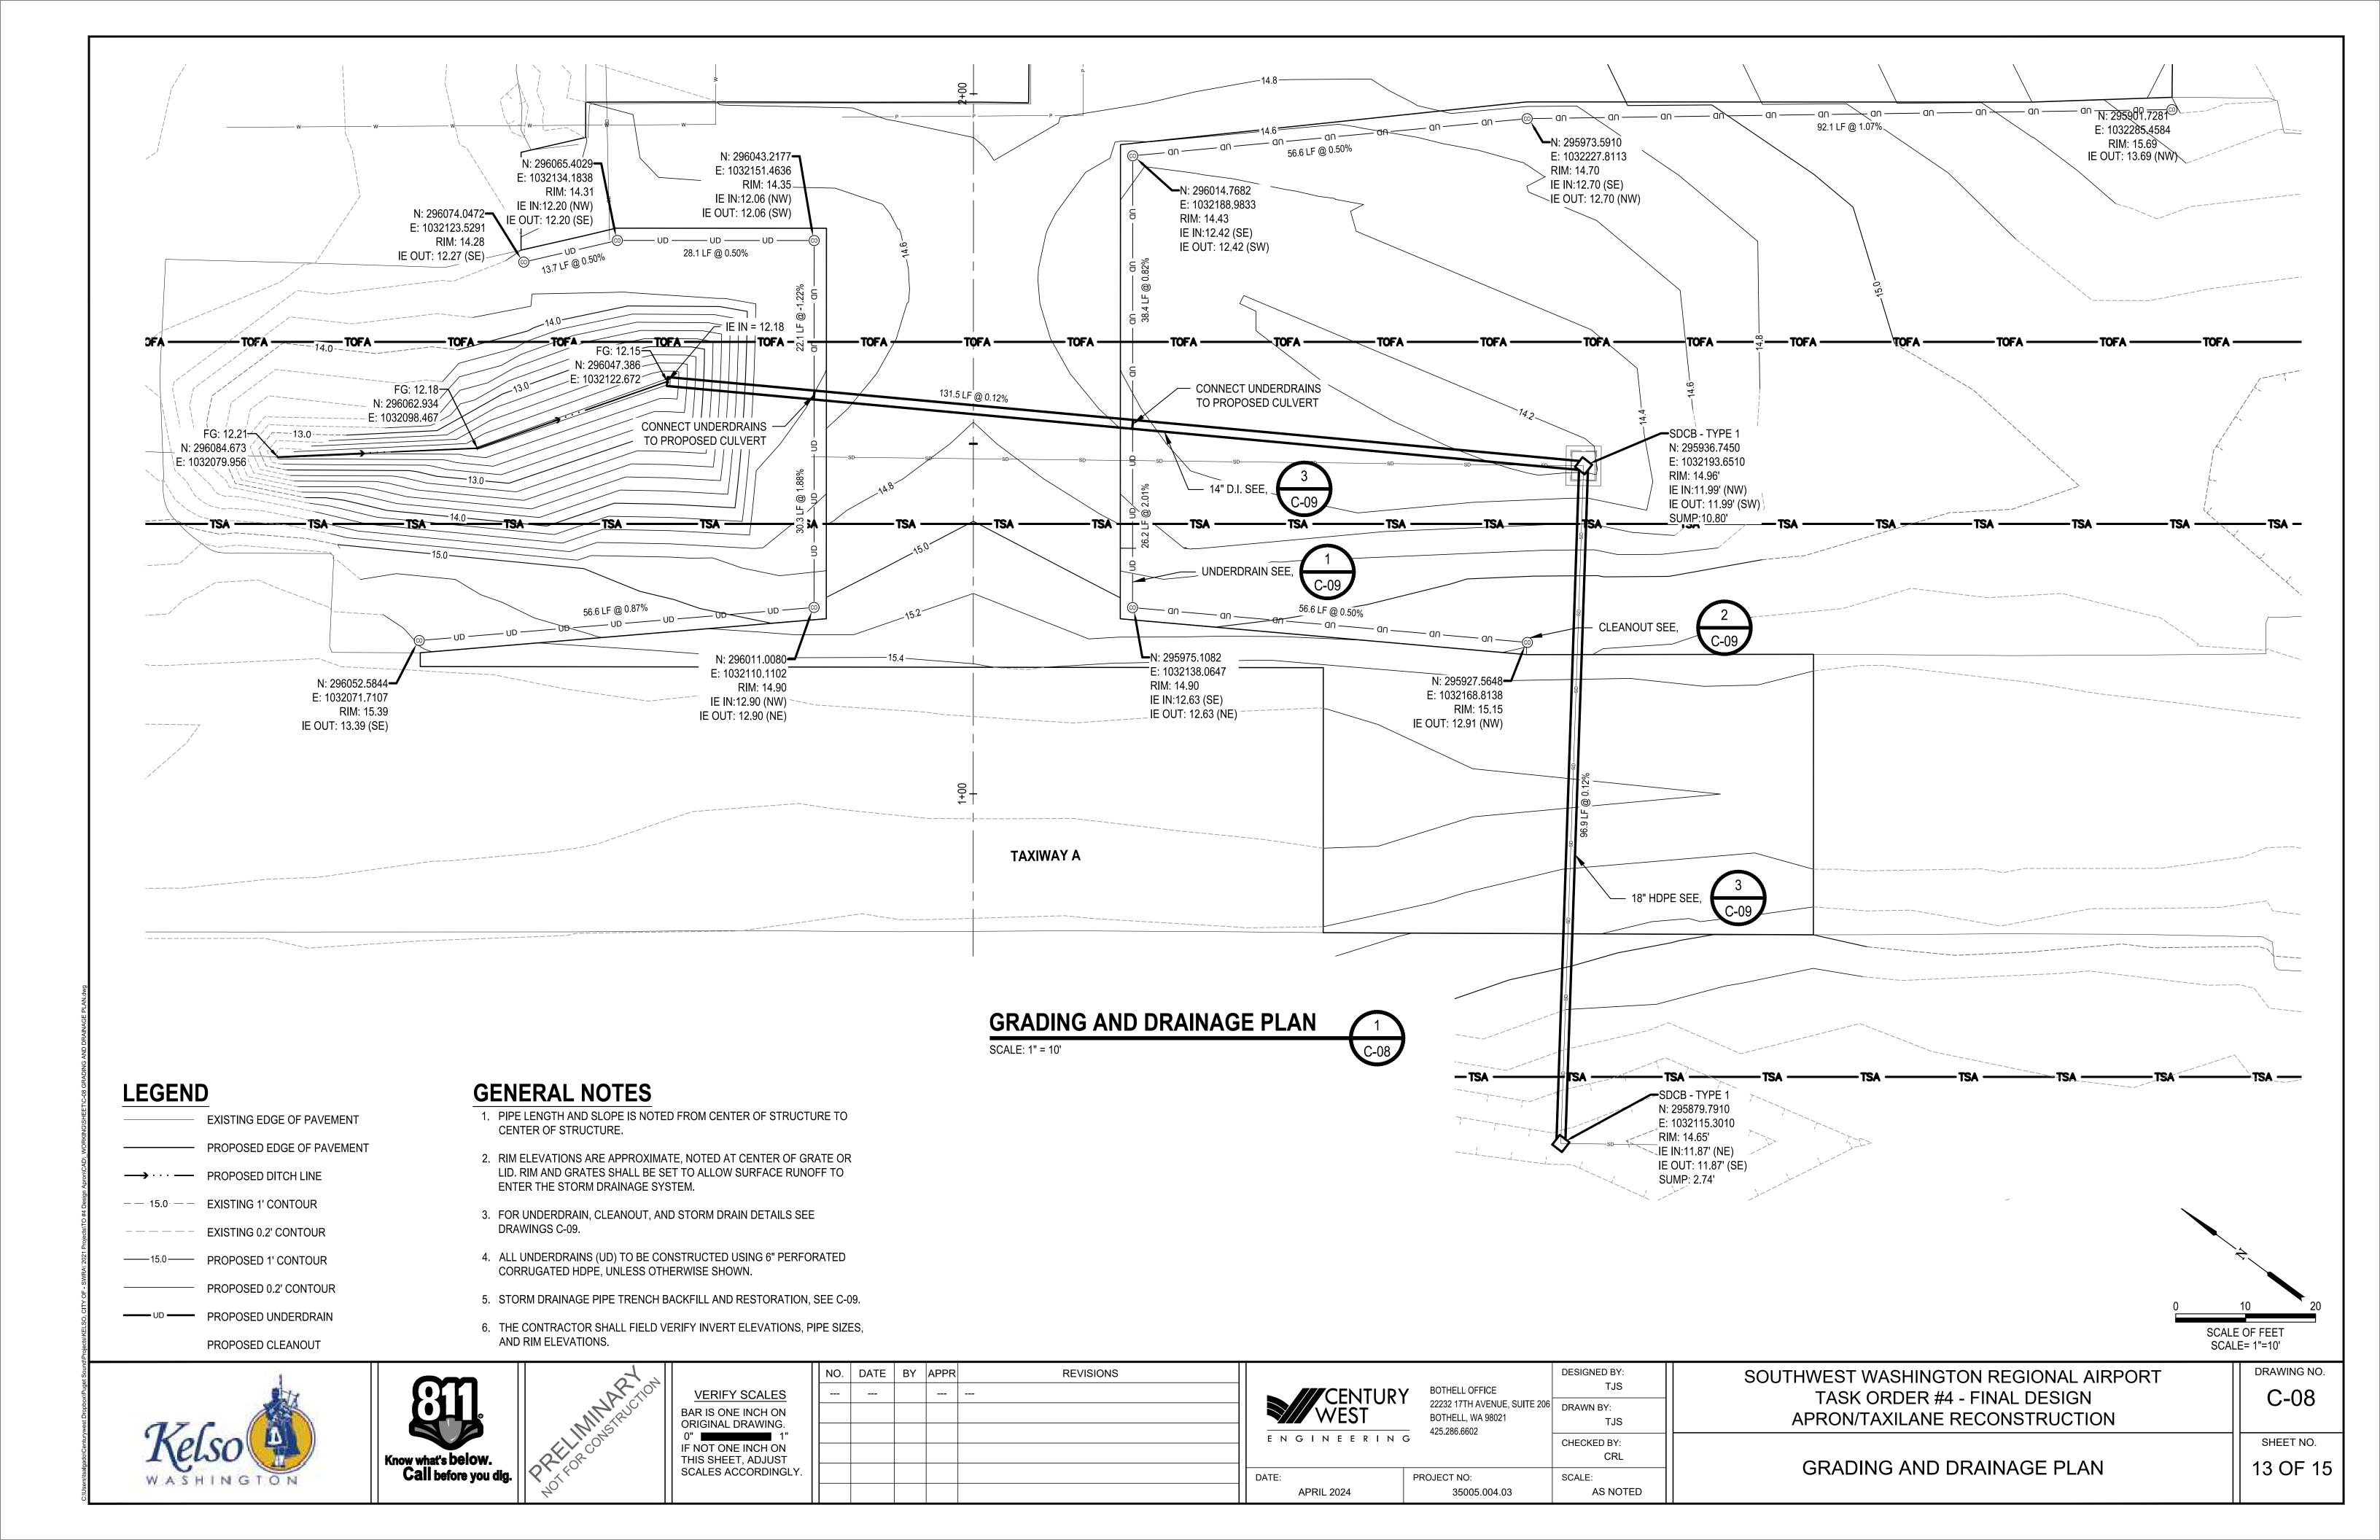
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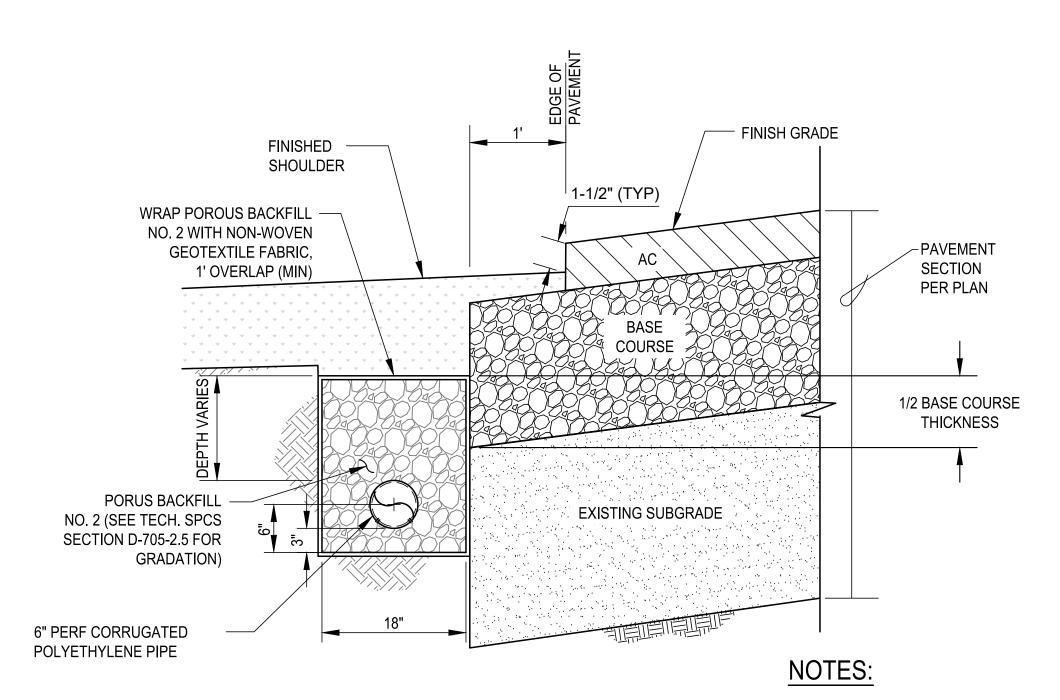
SOUTHWEST WASHINGTON REGIONAL AIRPORT TASK ORDER #4 - FINAL DESIGN APRON/TAXILANE RECONSTRUCTION

SHEET NO.

12 OF 15


PAVEMENT SECTIONS





1. UNDERDRAIN BEDDING SHALL BE PLACED AND COMPACTED BEFORE INSTALLATION OF UNDERDRAIN PIPE PER ITEM D-705.




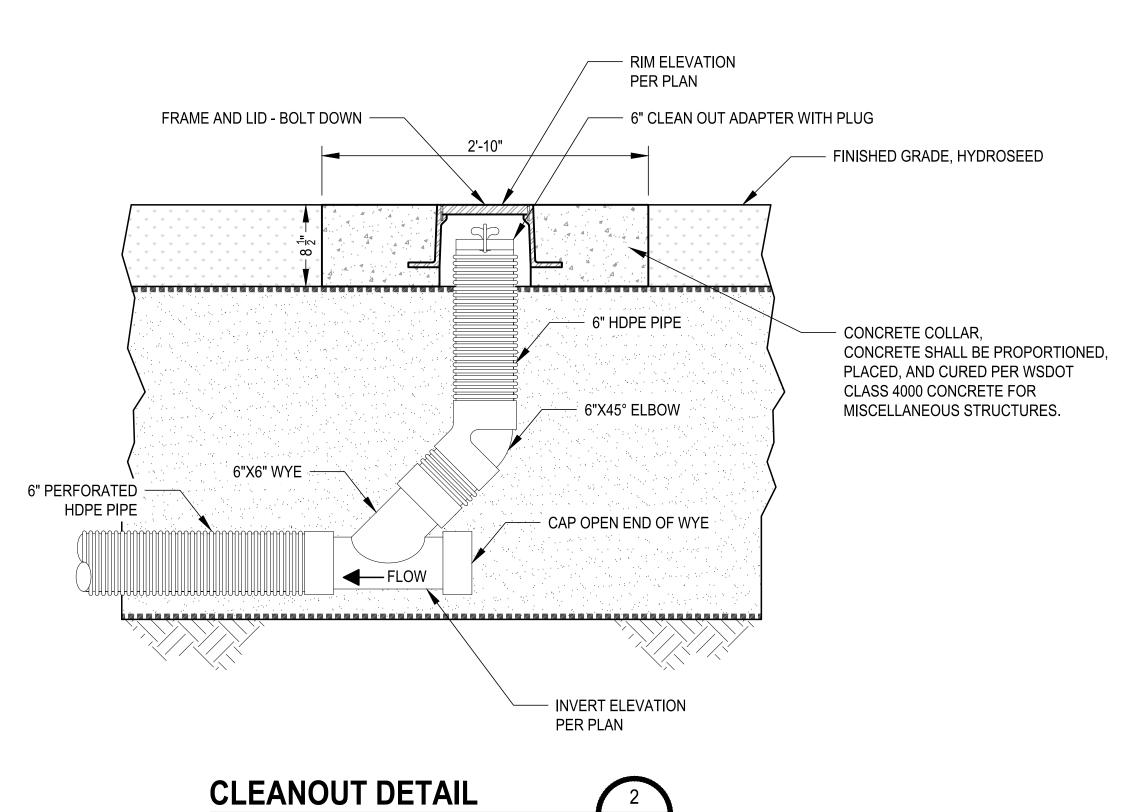







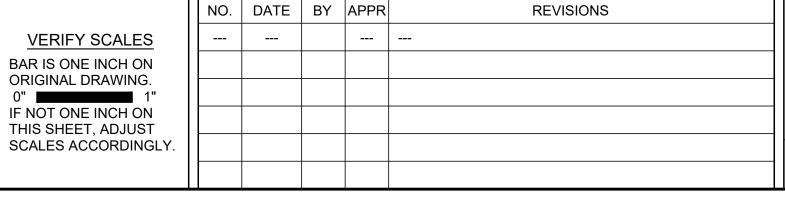



DESIGNED BY: CHECKED BY: CRL SCALE: AS NOTED

DRAWING NO. SOUTHWEST WASHINGTON REGIONAL AIRPORT TASK ORDER #4 - FINAL DESIGN APRON/TAXILANE RECONSTRUCTION

C-09 SHEET NO.

DRAINAGE DETAILS 14 OF 15

NOTES:

1. IN PAVED AREAS, TRENCH BACKFILL SHALL BE CLSM (P-153). IN NON-PAVED AREAS SHALL BE NATIVE BACKFILL THAT MEET REQUIRMENTS OF WSDOT SECTION 9-03.14(1). IF NOT, USE CRUSHED SURFACE TOP COURSE (CSTC) PER WSDOT SECTION 9-03.9(3).

PAVEMENT SECTION

EXISTING SUBGRADE

PIPE ZONE BEDDING (PAVED):

IF THE TRENCH BOTTOM IS DETERMINED TO BE UNSUITABLE BY THE ENGINEER, THE UNSUITABLE FOUNDATION MATERIAL SHALL BE REMOVED & REPLACED WITH PIPE FOUNDATION MATERIAL

AGGREGATE FOR GRAVEL BASE PER WSDOT SECTION 9-03.10

CLSM (P-153)

TOPSOIL & SEEDING PER PLAN

(SEE NOTE 3)

NATIVE MATERIAL

PIPE ZONE BEDDING:

PER WSDOT SECTION 9-03.9(3)

CRUSHED SURFACING TOP COURSE (CSTC)

(SEE NOTE 2)

- 2. ALL BACKFILL SHALL BE COMPACTED TO 95% MAXIMUM DENSITY.
- 3. TOPSOIL AND SEEDING SHALL BE MEASURED AND PAID FOR UNDER RESPECTIVE BID ITEMS AND NOT INCLUDED WITH THE 16" DUCTILE IRON STORM SEWER PIPE BID ITEM.



